Verizon

VERIZON SITE NUMBER: 115542

MOUNTAIN SOLOMON AT HIGHWAY 101

SANTA MARIA. CA 93454

SANTA BARBARA

101-020-074

EXISTING

-120.383356

34.834897

NAD83 ±1347 FT

VERIZON SITE NAME:

SITE TYPE:

TOWER HEIGHT:

SHEET#

SANTA MARIA (L-SUB6) SELF SUPPORT TOWER

100'-0"

BUSINESS UNIT #: 845141

SITE ADDRESS:

COUNTY:

DATE

JURISDICTION:

MOUNTAIN SOLOMON AT HIGHWAY 101

SANTA MARIA, CA 93454

SANTA BARBARA **COUNTY OF**

SANTA BARBARA

VERIZON 60403951

SITE ACQUISITION

CONSTRUCTION

RADIO

TELCO

MICROWAVE

EQUIPMENT

PROJECT ADMINISTRATOR

CROWN CASTLE USA INC. SI<mark>GNATU</mark>RE BLOCK

WO ADMINISTRATOR

SITE ACQUISITION

CONSTRUCTION

UTILITY MANAGER

LANDLORD

VERIZON SIGNATURE BLOCK

APPROVALS

SIGNATURE

SIGNATURE

SITE INFORMATION

CROWN CASTLE USA INC. SITE NAME:

SB05-01 MT SOLOMON

SITE ADDRESS:

COUNTY: AREA OF CONSTRUCTION:

LATITUDE: LONGITUDE:

LAT/LONG TYPE: GROUND ELEVATION: **CURRENT ZONING:**

JURISDICTION: OCCUPANCY CLASSIFICATION: U

TYPE OF CONSTRUCTION:

A.D.A. COMPLIANCE:

FACILITY IS UNMANNED AND NOT FOR **HUMAN HABITATION**

TPA IV LLC PROPERTY OWNER:

TOWER OWNER:

VERIZON WIRELESS CARRIER/APPLICANT: 3245 158TH AVENUE MS 231

BELLEVUE, WA 98008

ELECTRIC PROVIDER:

TELCO PROVIDER:

A&E FIRM:

CONTACTS:

CROWN CASTLE

USA INC. DISTRICT

EXISTING EXISTING

PROJECT TEAM

STACIE ESPOSITO - PROJECT MANAGER

GARY HORACE - CONSTRUCTION MANAGER

OVERALL SITE PLAN SITE PLAN EXISTING & NEW ELEVATION ANTENNA PLANS & CABLE SCHEDULE

TITLE SHEET

GENERAL NOTES

GROUNDING PLAN

GROUNDING DETAILS

GROUNDING DETAILS

DRAWING INDEX

SHEET DESCRIPTION

EQUIPMENT SPECS EQUIPMENT SPECS COUNTY OF SANTA BARBARA CONFIGURATION DIAGRAM

> ALL DRAWINGS CONTAINED HEREIN ARE FORMATTED FOR DIMENSIONS AND CONDITIONS ON THE JOB SITE AND SHALL IMMEDIATELY NOTIFY THE ENGINEER IN WRITING OF ANY DISCREPANCIES BEFORE PROCEEDING WITH THE WORK OR BE RESPONSIBLE FOR SAME.

PROJECT DESCRIPTION

THE PURPOSE OF THIS PROJECT IS TO ENHANCE BROADBAND CONNECTIVITY AND CAPACITY TO THE EXISTING ELIGIBLE WIRELESS FACILITY.

PRIOR TO ACCESSING/ENTERING THE SITE YOU MUST

CONTACT THE CROWN NOC AT (800) 788-7011 & CROWN

TOWER SCOPE OF WORK:

- REMOVE (12) ANTENNAS
- REMOVE (3) TMAS
- INSTALL (9) ANTENNAS
- INSTALL (6) RRUS • INSTALL (2) OVPS
- INSTALL (2) HYBRID CABLES
- ROUND SCOPE OF WORK:
- REMOVE (6) RUL01 B13

CONSTRUCTION MANAGER

• REMOVE (3) RRUS 2212

https://pmi.vxwsmart.com PMI ACCESSED AT SMART TOOL VENDOR PROJECT NUMBER VzW LOCATION CODE (PSLC) *** PMI AND REQUIREMENTS ALSO EMBEDDED IN MOUNT

CONTRACTOR PMI REQUIREMENTS

MOUNT MODIFICATION REQUIRED

ANALYSIS REPORT

VzW APPROVED SMART KIT VENDORS

REFER TO MOUNT MODIFICATION DRAWINGS PAGE FOR VzW SMART KIT APPROVED VENDORS

LOCATION MAP



DRIVING DIRECTIONS FROM SANTA MARIA AIRPORT

- CONTINUE ONTO LAKEVIEW RD
- TURN LEFT ONTO S BRADLEY RD - TURN RIGHT ONTO SANTA MARIA WAY
- USE THE RIGHT LANE TO TAKE THE US-101 N RAMP
- MERGE WITH US-101 S - TURN RIGHT
- TURN RIGHT
- ARRIVE AT MOUNTAIN SOLOMON AT HIGHWAY 101 SANTA MARIA, CA 93454

APPLICABLE CODES/REFERENCE **DOCUMENTS**

ALL WORK SHALL BE PERFORMED AND MATERIALS INSTALLED IN ACCORDANCE WITH THE CURRENT EDITIONS OF THE FOLLOWING CODES AS ADOPTED BY THE LOCAL GOVERNING AUTHORITIES. NOTHING IN THESE PLANS IS TO BE CONSTRUED TO PERMIT WORK NOT CONFORMING TO THESE CODES:

CODE TYPE CODE 2019 CBC BUILDING 2019 CMC **MECHANICAL** 2019 CEC ELECTRICAL

REFERENCE DOCUMENTS:

STRUCTURAL ANALYSIS: BY OTHERS DATED:


MOUNT ANALYSIS: BY OTHERS

DATED:

RFDS REVISION: 1

DATED: 02/08/2021 ORDER ID: 555652

REVISION: ----

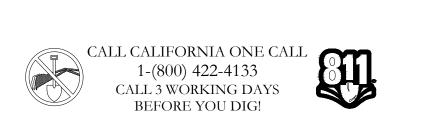

BELLEVUE, WA 98008 **CROWN CASTLE**

SEATTLE, WA 98109

JURISDICTIONAL APPROVAL:

VERIZON SITE NUMBER: 115542

BU #: **845141** SB05-01 MT SOLOMON

MOUNTAIN SOLOMON AT HIGHWAY 101 SANTA MARIA, CA 93454 EXISTING 100'-0" SELF SUPPORT TOWER

ISSUED FOR: DRWN DESCRIPTION DES./QA 05/06/2021 SA 90% CD'S

THIS DOCUMENT IS PRELIMINARY IN NATURE AND IS NOT A FINAL, SIGNED AND **SEALED DOCUMENT**

IT IS A VIOLATION OF LAW FOR ANY PERSON, JNLESS THEY ARE ACTING UNDER THE DIRECTION OF A LICENSED PROFESSIONAL ENGINEER, TO ALTER THIS DOCUMENT.

SHEET NUMBER:



CROWN CASTLE USA INC. SITE ACTIVITY REQUIREMENTS:

- 1. NOTICE TO PROCEED— NO WORK SHALL COMMENCE PRIOR TO CROWN CASTLE USA INC. WRITTEN NOTICE TO PROCEED (NTP) AND THE ISSUANCE OF A PURCHASE ORDER. PRIOR TO ACCESSING/ENTERING THE SITE YOU MUST CONTACT THE CROWN CASTLE USA INC. NOC AT 800-788-7011 & THE CROWN CASTLE USA INC. CONSTRUCTION MANAGER.
- 2. "LOOK UP" CROWN CASTLE USA INC. SAFETY CLIMB REQUIREMENT:
- THE INTEGRITY OF THE SAFETY CLIMB AND ALL COMPONENTS OF THE CLIMBING FACILITY SHALL BE CONSIDERED DURING ALL STAGES OF DESIGN, INSTALLATION, AND INSPECTION. TOWER MODIFICATION, MOUNT REINFORCEMENTS, AND/OR EQUIPMENT INSTALLATIONS SHALL NOT COMPROMISE THE INTEGRITY OR FUNCTIONAL USE OF THE SAFETY CLIMB OR ANY COMPONENTS OF THE CLIMBING FACILITY ON THE STRUCTURE. THIS SHALL INCLUDE, BUT NOT BE LIMITED TO: PINCHING OF THE WIRE ROPE, BENDING OF THE WIRE ROPE FROM ITS SUPPORTS, DIRECT CONTACT OR CLOSE PROXIMITY TO THE WIRE ROPE WHICH MAY CAUSE FRICTIONAL WEAR, IMPACT TO THE ANCHORAGE POINTS IN ANY WAY, OR TO IMPEDE/BLOCK ITS INTENDED USE. ANY COMPROMISED SAFETY CLIMB, INCLUDING EXISTING CONDITIONS MUST BE TAGGED OUT AND REPORTED TO YOUR CROWN CASTLE USA INC. POC OR CALL THE NOC TO GENERATE A SAFETY CLIMB MAINTENANCE AND CONTRACTOR NOTICE TICKET.
- 3. PRIOR TO THE START OF CONSTRUCTION, ALL REQUIRED JURISDICTIONAL PERMITS SHALL BE OBTAINED. THIS INCLUDES, BUT IS NOT LIMITED TO, BUILDING, ELECTRICAL, MECHANICAL, FIRE, FLOOD ZONE, ENVIRONMENTAL, AND ZONING. AFTER ONSITE ACTIVITIES AND CONSTRUCTION ARE COMPLETED, ALL REQUIRED PERMITS SHALL BE SATISFIED AND CLOSED OUT ACCORDING TO LOCAL JURISDICTIONAL REQUIREMENTS.
- 4. ALL CONSTRUCTION MEANS AND METHODS; INCLUDING BUT NOT LIMITED TO, ERECTION PLANS, RIGGING PLANS, CLIMBING PLANS, AND RESCUE PLANS SHALL BE THE RESPONSIBILITY OF THE GENERAL CONTRACTOR RESPONSIBLE FOR THE EXECUTION OF THE WORK CONTAINED HEREIN, AND SHALL MEET ANSI/ASSE A10.48 (LATEST EDITION); FEDERAL, STATE, AND LOCAL REGULATIONS; AND ANY APPLICABLE INDUSTRY CONSENSUS STANDARDS RELATED TO THE CONSTRUCTION ACTIVITIES BEING PERFORMED. ALL RIGGING PLANS SHALL ADHERE TO ANSI/ASSE A10.48 (LATEST EDITION) AND CROWN CASTLE USA INC. STANDARD CED-STD-10253, INCLUDING THE REQUIRED INVOLVEMENT OF A QUALIFIED ENGINEER FOR CLASS IV CONSTRUCTION, TO CERTIFY THE SUPPORTING STRUCTURE(S) IN ACCORDANCE WITH ANSI/TIA-322 (LATEST EDITION).
- 5. ALL SITE WORK TO COMPLY WITH QAS-STD-10068 "INSTALLATION STANDARDS FOR CONSTRUCTION ACTIVITIES ON CROWN CASTLE USA INC. TOWER SITE," CED-STD-10294 "STANDARD FOR INSTALLATION OF MOUNTS AND APPURTENANCES," AND LATEST VERSION OF ANSI/TIA-1019-A-2012 "STANDARD FOR INSTALLATION, ALTERATION, AND MAINTENANCE OF ANTENNA SUPPORTING STRUCTURES AND ANTENNAS."
- 6. IF THE SPECIFIED EQUIPMENT CAN NOT BE INSTALLED AS SHOWN ON THESE DRAWINGS, THE CONTRACTOR SHALL PROPOSE AN ALTERNATIVE INSTALLATION FOR APPROVAL BY CROWN CASTLE USA INC. PRIOR TO PROCEEDING WITH ANY SUCH CHANGE OF INSTALLATION.
- 7. ALL MATERIALS FURNISHED AND INSTALLED SHALL BE IN STRICT ACCORDANCE WITH ALL APPLICABLE CODES, REGULATIONS AND ORDINANCES. CONTRACTOR SHALL ISSUE ALL APPROPRIATE NOTICES AND COMPLY WITH ALL LAWS, ORDINANCES, RULES, REGULATIONS AND LAWFUL ORDERS OF ANY PUBLIC AUTHORITY REGARDING THE PERFORMANCE OF THE WORK. ALL WORK CARRIED OUT SHALL COMPLY WITH ALL APPLICABLE MUNICIPAL AND UTILITY COMPANY SPECIFICATIONS AND LOCAL JURISDICTIONAL CODES, ORDINANCES AND APPLICABLE REGULATIONS.
- 8. THE CONTRACTOR SHALL INSTALL ALL EQUIPMENT AND MATERIALS IN ACCORDANCE WITH MANUFACTURER'S RECOMMENDATIONS UNLESS SPECIFICALLY STATED OTHERWISE.
- 9. THE CONTRACTOR SHALL CONTACT UTILITY LOCATING SERVICES PRIOR TO THE START OF CONSTRUCTION.
- 10. ALL EXISTING ACTIVE SEWER, WATER, GAS, ELECTRIC AND OTHER UTILITIES WHERE ENCOUNTERED IN THE WORK, SHALL BE PROTECTED AT ALL TIMES AND WHERE REQUIRED FOR THE PROPER EXECUTION OF THE WORK, SHALL BE RELOCATED AS DIRECTED BY CONTRACTOR. EXTREME CAUTION SHOULD BE USED BY THE CONTRACTOR WHEN EXCAVATING OR DRILLING PIERS AROUND OR NEAR UTILITIES. CONTRACTOR SHALL PROVIDE SAFETY TRAINING FOR THE WORKING CREW. THIS WILL INCLUDE BUT NOT BE LIMITED TO A) FALL PROTECTION B) CONFINED SPACE C) ELECTRICAL SAFETY D) TRENCHING AND EXCAVATION E) CONSTRUCTION SAFETY PROCEDURES.
- 11. ALL SITE WORK SHALL BE AS INDICATED ON THE STAMPED CONSTRUCTION DRAWINGS AND PROJECT SPECIFICATIONS, LATEST APPROVED REVISION.
- 12. CONTRACTOR SHALL KEEP THE SITE FREE FROM ACCUMULATING WASTE MATERIAL, DEBRIS, AND TRASH AT THE COMPLETION OF THE WORK. IF NECESSARY, RUBBISH, STUMPS, DEBRIS, STICKS, STONES AND OTHER REFUSE SHALL BE REMOVED FROM THE SITE AND DISPOSED OF LEGALLY.
- 13. ALL EXISTING INACTIVE SEWER, WATER, GAS, ELECTRIC AND OTHER UTILITIES, WHICH INTERFERE WITH THE EXECUTION OF THE WORK, SHALL BE REMOVED AND/OR CAPPED, PLUGGED OR OTHERWISE DISCONTINUED AT POINTS WHICH WILL NOT INTERFERE WITH THE EXECUTION OF THE WORK, SUBJECT TO THE APPROVAL OF CONTRACTOR, TOWER OWNER, CROWN CASTLE USA INC., AND/OR LOCAL UTILITIES.
- 14. THE CONTRACTOR SHALL PROVIDE SITE SIGNAGE IN ACCORDANCE WITH THE TECHNICAL SPECIFICATION FOR SITE SIGNAGE REQUIRED BY LOCAL JURISDICTION AND SIGNAGE REQUIRED ON INDIVIDUAL PIECES OF EQUIPMENT, ROOMS, AND SHELTERS.
- 15. THE SITE SHALL BE GRADED TO CAUSE SURFACE WATER TO FLOW AWAY FROM THE CARRIER'S EQUIPMENT AND TOWER AREAS.
- 16. THE SUB GRADE SHALL BE COMPACTED AND BROUGHT TO A SMOOTH UNIFORM GRADE PRIOR TO FINISHED SUBFACE APPLICATION
- 17. THE AREAS OF THE OWNERS PROPERTY DISTURBED BY THE WORK AND NOT COVERED BY THE TOWER, EQUIPMENT OR DRIVEWAY, SHALL BE GRADED TO A UNIFORM SLOPE, AND STABILIZED TO PREVENT
- EROSION AS SPECIFIED ON THE CONSTRUCTION DRAWINGS AND/OR PROJECT SPECIFICATIONS.

 18. CONTRACTOR SHALL MINIMIZE DISTURBANCE TO EXISTING SITE DURING CONSTRUCTION. EROSION CONTROL MEASURES, IF REQUIRED DURING CONSTRUCTION, SHALL BE IN CONFORMANCE WITH THE LOCAL GUIDELINES FOR EROSION AND SEDIMENT CONTROL.
- 19. THE CONTRACTOR SHALL PROTECT EXISTING IMPROVEMENTS, PAVEMENTS, CURBS, LANDSCAPING AND STRUCTURES. ANY DAMAGED PART SHALL BE REPAIRED AT CONTRACTOR'S EXPENSE TO THE SATISFACTION OF OWNER.
- 20. CONTRACTOR SHALL LEGALLY AND PROPERLY DISPOSE OF ALL SCRAP MATERIALS SUCH AS COAXIAL CABLES AND OTHER ITEMS REMOVED FROM THE EXISTING FACILITY. ANTENNAS REMOVED SHALL BE RETURNED TO THE OWNER'S DESIGNATED LOCATION.
- 21. CONTRACTOR SHALL LEAVE PREMISES IN CLEAN CONDITION. TRASH AND DEBRIS SHOULD BE REMOVED FROM SITE ON A DAILY BASIS.
- 22. NO FILL OR EMBANKMENT MATERIAL SHALL BE PLACED ON FROZEN GROUND. FROZEN MATERIALS, SNOW OR ICE SHALL NOT BE PLACED IN ANY FILL OR EMBANKMENT.

GENERAL NOTES:

- I. FOR THE PURPOSE OF CONSTRUCTION DRAWING, THE FOLLOWING DEFINITIONS SHALL APPLY: CONTRACTOR: GENERAL CONTRACTOR RESPONSIBLE FOR CONSTRUCTION
- CARRIER: VERIZON TOWER OWNER: CROWN CASTLE USA INC.
- 2. THESE DRAWINGS HAVE BEEN PREPARED USING STANDARDS OF PROFESSIONAL CARE AND COMPLETENESS NORMALLY EXERCISED UNDER SIMILAR CIRCUMSTANCES BY REPUTABLE ENGINEERS IN THIS OR SIMILAR LOCALITIES. IT IS ASSUMED THAT THE WORK DEPICTED WILL BE PERFORMED BY AN EXPERIENCED CONTRACTOR AND/OR WORKPEOPLE WHO HAVE A WORKING KNOWLEDGE OF THE APPLICABLE CODE STANDARDS AND REQUIREMENTS AND OF INDUSTRY ACCEPTED STANDARD GOOD PRACTICE. AS NOT EVERY CONDITION OR ELEMENT IS (OR CAN BE) EXPLICITLY SHOWN ON THESE DRAWINGS, THE CONTRACTOR SHALL USE INDUSTRY ACCEPTED STANDARD GOOD PRACTICE FOR MISCELLANFOUS WORK NOT EXPLICITLY SHOWN.
- 3. THESE DRAWINGS REPRESENT THE FINISHED STRUCTURE. THEY DO NOT INDICATE THE MEANS OR METHODS OF CONSTRUCTION. THE CONTRACTOR SHALL BE SOLELY RESPONSIBLE FOR THE CONSTRUCTION MEANS, METHODS, TECHNIQUES, SEQUENCES, AND PROCEDURES. THE CONTRACTOR SHALL PROVIDE ALL MEASURES NECESSARY FOR PROTECTION OF LIFE AND PROPERTY DURING CONSTRUCTION. SUCH MEASURES SHALL INCLUDE, BUT NOT BE LIMITED TO, BRACING, FORMWORK, SHORING, ETC. SITE VISITS BY THE ENGINEER OR HIS REPRESENTATIVE WILL NOT INCLUDE INSPECTION OF THESE ITEMS AND IS FOR STRUCTURAL OBSERVATION OF THE FINISHED STRUCTURE ONLY.
- 4. NOTES AND DETAILS IN THE CONSTRUCTION DRAWINGS SHALL TAKE PRECEDENCE OVER GENERAL NOTES AND TYPICAL DETAILS. WHERE NO DETAILS ARE SHOWN, CONSTRUCTION SHALL CONFORM TO SIMILAR WORK ON THE PROJECT, AND/OR AS PROVIDED FOR IN THE CONTRACT DOCUMENTS. WHERE DISCREPANCIES OCCUR BETWEEN PLANS, DETAILS, GENERAL NOTES, AND SPECIFICATIONS, THE GREATER, MORE STRICT REQUIREMENTS, SHALL GOVERN. IF FURTHER CLARIFICATION IS REQUIRED CONTACT THE ENGINEER OF RECORD.
- 5. SUBSTANTIAL EFFORT HAS BEEN MADE TO PROVIDE ACCURATE DIMENSIONS AND MEASUREMENTS ON THE DRAWINGS TO ASSIST IN THE FABRICATION AND/OR PLACEMENT OF CONSTRUCTION ELEMENTS BUT IT IS THE SOLE RESPONSIBILITY OF THE CONTRACTOR TO FIELD VERIFY THE DIMENSIONS, MEASUREMENTS, AND/OR CLEARANCES SHOWN IN THE CONSTRUCTION DRAWINGS PRIOR TO FABRICATION OR CUTTING OF ANY NEW OR EXISTING CONSTRUCTION ELEMENTS. IF IT IS DETERMINED THAT THERE ARE DISCREPANCIES AND/OR CONFLICTS WITH THE CONSTRUCTION DRAWINGS THE ENGINEER OF RECORD IS TO BE NOTIFIED AS SOON AS POSSIBLE.
- 6. PRIOR TO THE SUBMISSION OF BIDS, THE BIDDING CONTRACTOR SHALL VISIT THE CELL SITE TO FAMILIARIZE WITH THE EXISTING CONDITIONS AND TO CONFIRM THAT THE WORK CAN BE ACCOMPLISHED AS SHOWN ON THE CONSTRUCTION DRAWINGS. ANY DISCREPANCY FOUND SHALL BE BROUGHT TO THE ATTENTION OF CROWN CASTLE.
- 7. ALL MATERIALS FURNISHED AND INSTALLED SHALL BE IN STRICT ACCORDANCE WITH ALL APPLICABLE CODES, REGULATIONS AND ORDINANCES. CONTRACTOR SHALL ISSUE ALL APPROPRIATE NOTICES AND COMPLY WITH ALL LAWS, ORDINANCES, RULES, REGULATIONS AND LAWFUL ORDERS OF ANY PUBLIC AUTHORITY REGARDING THE PERFORMANCE OF THE WORK. ALL WORK CARRIED OUT SHALL COMPLY WITH ALL APPLICABLE MUNICIPAL AND UTILITY COMPANY SPECIFICATIONS AND LOCAL JURISDICTIONAL CODES, ORDINANCES AND APPLICABLE REGULATIONS.
- 8. UNLESS NOTED OTHERWISE, THE WORK SHALL INCLUDE FURNISHING MATERIALS, EQUIPMENT, APPURTENANCES AND LABOR NECESSARY TO COMPLETE ALL INSTALLATIONS AS INDICATED ON THE DRAWINGS.
- 9. THE CONTRACTOR SHALL INSTALL ALL EQUIPMENT AND MATERIALS IN ACCORDANCE WITH MANUFACTURER'S RECOMMENDATIONS UNLESS SPECIFICALLY STATED OTHERWISE.
- 10. IF THE SPECIFIED EQUIPMENT CAN NOT BE INSTALLED AS SHOWN ON THESE DRAWINGS, THE CONTRACTOR SHALL PROPOSE AN ALTERNATIVE INSTALLATION FOR APPROVAL BY THE CARRIER AND CROWN CASTLE PRIOR TO PROCEEDING
- WITH ANY SUCH CHANGE OF INSTALLATION.

 11. CONTRACTOR IS TO PERFORM A SITE INVESTIGATION AND IS TO DETERMINE THE BEST ROUTING OF ALL CONDUITS FOR POWER, AND TELCO AND FOR GROUNDING CABLES AS SHOWN IN THE POWER, TELCO, AND GROUNDING PLAN
- DRAWINGS.

 12. THE CONTRACTOR SHALL PROTECT EXISTING IMPROVEMENTS, PAVEMENTS, CURBS, LANDSCAPING AND STRUCTURES. ANY DAMAGED PART SHALL BE REPAIRED AT CONTRACTOR'S EXPENSE TO THE SATISFACTION OF CROWN CASTLE USA INC.
- 13. CONTRACTOR SHALL LEGALLY AND PROPERLY DISPOSE OF ALL SCRAP MATERIALS SUCH AS COAXIAL CABLES AND OTHER ITEMS REMOVED FROM THE EXISTING FACILITY. ANTENNAS REMOVED SHALL BE RETURNED TO THE OWNER'S DESIGNATED LOCATION.
- 14. CONTRACTOR SHALL LEAVE PREMISES IN CLEAN CONDITION. TRASH AND DEBRIS SHOULD BE REMOVED FROM SITE ON A DAILY BASIS.

CONCRETE, FOUNDATIONS, AND REINFORCING STEEL

- 1. ALL CONCRETE WORK SHALL BE IN ACCORDANCE WITH THE ACI 301, ACI 318, ACI 336, ASTM A184, ASTM A185 AND THE DESIGN AND CONSTRUCTION SPECIFICATION FOR CAST—IN—PLACE CONCRETE.

 2. UNLESS NOTED OTHERWISE, SOIL BEARING PRESSURE USED FOR DESIGN OF SLABS AND FOUNDATIONS IS ASSUMED
- TO BE 1000 psf.

 3. ALL CONCRETE SHALL HAVE A MINIMUM COMPRESSIVE STRENGTH (f'c) OF 3000 psi AT 28 DAYS, UNLESS NOTED OTHERWISE. NO MORE THAN 90 MINUTES SHALL ELAPSE FROM BATCH TIME TO TIME OF PLACEMENT UNLESS APPROVED BY THE ENGINEER OF RECORD. TEMPERATURE OF CONCRETE SHALL NOT EXCEED 90°f AT TIME OF
- 4. CONCRETE EXPOSED TO FREEZE—THAW CYCLES SHALL CONTAIN AIR ENTRAINING ADMIXTURES. AMOUNT OF AIR ENTRAINMENT TO BE BASED ON SIZE OF AGGREGATE AND F3 CLASS EXPOSURE (VERY SEVERE). CEMENT USED TO BE TYPE II PORTLAND CEMENT WITH A MAXIMUM WATER—TO—CEMENT RATIO (W/C) OF 0.45.
- ALL STEEL REINFORCING SHALL CONFORM TO ASTM A615. ALL WELDED WIRE FABRIC (WWF) SHALL CONFORM TO ASTM A185. ALL SPLICES SHALL BE CLASS "B" TENSION SPLICES, UNLESS NOTED OTHERWISE. ALL HOOKS SHALL BE STANDARD 90 DEGREE HOOKS, UNLESS NOTED OTHERWISE. YIELD STRENGTH (Fy) OF STANDARD DEFORMED BARS ARE AS FOLLOWS:

- 7. A TOOLED EDGE OR A 3/4" CHAMFER SHALL BE PROVIDED AT ALL EXPOSED EDGES OF CONCRETE, UNLESS NOTED OTHERWISE, IN ACCORDANCE WITH ACI 301 SECTION 4.2.4.

GREENFIELD GROUNDING NOTES:

- 1. ALL GROUND ELECTRODE SYSTEMS (INCLUDING TELECOMMUNICATION, RADIO, LIGHTNING PROTECTION AND AC POWER GES'S) SHALL BE BONDED TOGETHER AT OR BELOW GRADE, BY TWO OR MORE COPPER BONDING CONDUCTORS IN ACCORDANCE WITH THE NEC.
- 2. THE CONTRACTOR SHALL PERFORM IEEE FALL—OF—POTENTAL RESISTANCE TO EARTH TESTING (PER IEEE 1100 AND 81) FOR GROUND ELECTRODE SYSTEMS, THE CONTRACTOR SHALL FURNISH AND INSTALL SUPPLEMENTAL GROUND ELECTRODES AS NEEDED TO ACHIEVE A TEST RESULT OF 5 OHMS OR LESS.

 3. THE CONTRACTOR IS RESPONSIBLE FOR PROPERLY SEQUENCING GROUNDING AND UNDERGROUND CONDUIT INSTALLATION AS TO PREVENT ANY LOSS OF CONTINUITY IN THE GROUNDING SYSTEM OR DAMAGE TO THE CONDUIT AND PROVIDE
- TESTING RESULTS.
 4. METAL CONDUIT AND TRAY SHALL BE GROUNDED AND MADE ELECTRICALLY CONTINUOUS WITH LISTED BONDING FITTINGS OR BY BONDING ACROSS THE DISCONTINUITY WITH #6 COPPER WIRE UL APPROVED GROUNDING TYPE CONDUIT
- CLAMPS.

 5. METAL RACEWAY SHALL NOT BE USED AS THE NEC REQUIRED EQUIPMENT GROUND CONDUCTOR. STRANDED COPPER CONDUCTORS WITH GREEN INSULATION, SIZED IN ACCORDANCE WITH THE NEC, SHALL BE FURNISHED AND INSTALLED.
- WITH THE POWER CIRCUITS TO BTS EQUIPMENT.
 6. EACH CABINET FRAME SHALL BE DIRECTLY CONNECTED TO THE MASTER GROUND BAR WITH GREEN INSULATED SUPPLEMENTAL EQUIPMENT GROUND WIRES, #6 STRANDED COPPER OR LARGER FOR INDOOR BTS; #2 BARE SOLID TINNED
- COPPER FOR OUTDOOR BTS.
 7. CONNECTIONS TO THE GROUND BUS SHALL NOT BE DOUBLED UP OR STACKED BACK TO BACK CONNECTIONS ON OPPOSITE SIDE OF THE GROUND BUS ARE PERMITTED.
- 8. ALL EXTERIOR GROUND CONDUCTORS BETWEEN EQUIPMENT/GROUND BARS AND THE GROUND RING SHALL BE #2 SOLID TINNED COPPER UNLESS OTHERWISE INDICATED.
- 9. ALUMINUM CONDUCTOR OR COPPER CLAD STEEL CONDUCTOR SHALL NOT BE USED FOR GROUNDING CONNECTIONS.
- 10. USE OF 90° BENDS IN THE PROTECTION GROUNDING CONDUCTORS SHALL BE AVOIDED WHEN 45° BENDS CAN BE ADEQUATELY SUPPORTED 11. EXOTHERMIC WELDS SHALL BE USED FOR ALL GROUNDING CONNECTIONS BELOW GRADE.
- 12. ALL GROUND CONNECTIONS ABOVE GRADE (INTERIOR AND EXTERIOR) SHALL BE FORMED USING HIGH PRESS CRIMPS.
- 13. COMPRESSION GROUND CONNECTIONS MAY BE REPLACED BY EXOTHERMIC WELD CONNECTIONS.

 14. ICE BRIDGE BONDING CONDUCTORS SHALL BE EXOTHERMICALLY BONDED OR BOLTED TO THE BRIDGE AND THE TOWER GROUND BAR.
- 14. ICE BRIDGE BONDING CONDUCTORS SHALL BE EXOTHERMICALLY BONDED OR BOLTED TO THE BRIDGE AND THE TOWER GROUND BAR.

 15. APPROVED ANTIOXIDANT COATINGS (i.e. CONDUCTIVE GEL OR PASTE) SHALL BE USED ON ALL COMPRESSION AND BOLTED GROUND CONNECTIONS.
- 16. ALL EXTERIOR GROUND CONNECTIONS SHALL BE COATED WITH A CORROSION RESISTANT MATERIAL.
 17. MISCELLANEOUS ELECTRICAL AND NON-ELECTRICAL METAL BOXES, FRAMES AND SUPPORTS SHALL BE BONDED TO THE GROUND RING, IN ACCORDANCE WITH THE NEC.
- 18. BOND ALL METALLIC OBJECTS WITHIN 6 ft OF MAIN GROUND RING WITH (1) #2 BARE SOLID TINNED COPPER GROUND CONDUCTOR.
- 19. GROUND CONDUCTORS USED FOR THE FACILITY GROUNDING AND LIGHTNING PROTECTION SYSTEMS SHALL NOT BE ROUTED THROUGH METALLIC OBJECTS THAT FORM A RING AROUND THE CONDUCTOR, SUCH AS METALLIC CONDUITS, METAL SUPPORT CLIPS OR SLEEVES THROUGH WALLS OR FLOORS. WHEN IT IS REQUIRED TO BE HOUSED IN CONDUIT TO MEET CODE REQUIREMENTS OR LOCAL CONDITIONS, NON—METALLIC MATERIAL SUCH AS PVC CONDUIT SHALL BE USED. WHERE USE OF METAL CONDUIT IS UNAVOIDABLE (i.e., NONMETALLIC CONDUIT PROHIBITED BY LOCAL CODE) THE GROUND CONDUCTOR SHALL BE BONDED TO EACH END OF THE METAL CONDUIT.
- 20. ALL GROUNDS THAT TRANSITION FROM BELOW GRADE TO ABOVE GRADE MUST BE #2 BARE SOLID TINNED COPPER IN 3/4" NON-METALLIC, FLEXIBLE CONDUIT FROM 24" BELOW GRADE TO WITHIN 3" TO 6" OF CAD-WELD TERMINATION POINT. THE EXPOSED END OF THE CONDUIT MUST BE SEALED WITH SILICONE CAULK. (ADD TRANSITIONING GROUND STANDARD DETAIL AS WELL).
- 21. BUILDINGS WHERE THE MAIN GROUNDING CONDUCTORS ARE REQUIRED TO BE ROUTED TO GRADE, THE CONTRACTOR SHALL ROUTE TWO GROUNDING CONDUCTORS FROM THE ROOFTOP, TOWERS, AND WATER TOWERS GROUNDING RING, TO THE EXISTING GROUNDING SYSTEM, THE GROUNDING STEEL COLUMNS, LIGHTNING PROTECTION SYSTEM, AND BUILDING MAIN WATER LINE (FERROUS OR NONFERROUS METAL PIPING ONLY).

ELECTRICAL INSTALLATION NOTES:

- ALL ELECTRICAL WORK SHALL BE PERFORMED IN ACCORDANCE WITH THE PROJECT SPECIFICATIONS, NEC AND ALL APPLICABLE FEDERAL, STATE, AND LOCAL CODES/ORDINANCES.
- 2. CONDUIT ROUTINGS ARE SCHEMATIC. CONTRACTOR SHALL INSTALL CONDUITS SO THAT ACCESS TO EQUIPMENT IS NOT BLOCKED AND TRIP HAZARDS ARE FLIMINATED.
- AND TRIP HAZARDS ARE ELIMINATED.

 3. WIRING, RACEWAY AND SUPPORT METHODS AND MATERIALS SHALL COMPLY WITH THE REQUIREMENTS OF THE NEC.
- 4. ALL CIRCUITS SHALL BE SEGREGATED AND MAINTAIN MINIMUM CABLE SEPARATION AS REQUIRED BY THE NEC.
 4.1. ALL EQUIPMENT SHALL BEAR THE UNDERWRITERS LABORATORIES LABEL OF APPROVAL, AND SHALL CONFORM TO
- REQUIREMENT OF THE NATIONAL ELECTRICAL CODE. 4.2. ALL OVERCURRENT DEVICES SHALL HAVE AN INTERRUPTING CURRENT RATING THAT SHALL BE GREATER THAN THE SHORT CIRCUIT CURRENT TO WHICH THEY ARE SUBJECTED, 22,000 AIC MINIMUM. VERYIFY AVAILABLE SHORT CIRCUIT CURRENT DOES

NOT EXCEED THE RATING OF ELECTRICAL EQUIPMENT IN ACCORDANCE WITH ARTICLE 110.24 NEC OR THE MOST CURRENT

- ADOPTED CODE PRE THE GOVERNING JURISDICTION.

 5. EACH END OF EVERY POWER PHASE CONDUCTOR, GROUNDING CONDUCTOR, AND TELCO CONDUCTOR OR CABLE SHALL BE LABELED WITH COLOR—CODED INSULATION OR ELECTRICAL TAPE (3M BRAND, 1/2" PLASTIC ELECTRICAL TAPE WITH UV
- PROTECTION, OR EQUAL). THE IDENTIFICATION METHOD SHALL CONFORM WITH NEC AND OSHA.

 ALL ELECTRICAL COMPONENTS SHALL BE CLEARLY LABELED WITH LAMICOID TAGS SHOWING THEIR RATED VOLTAGE, PHASE
 CONFIGURATION, WIRE CONFIGURATION, POWER OR AMPACITY RATING AND BRANCH CIRCUIT ID NUMBERS (i.e. PANEL BOARD AND CIRCUIT ID'S).
- PANEL BOARDS (ID NUMBERS) SHALL BE CLEARLY LABELED WITH PLASTIC LABELS.
- 8. ALL TIE WRAPS SHALL BE CUT FLUSH WITH APPROVED CUTTING TOOL TO REMOVE SHARP EDGES.
 9. ALL POWER AND EQUIPMENT GROUND WIRING IN TUBING OR CONDUIT SHALL BE SINGLE COPPER CONDUCTOR (#14 OR LARGER)
- WITH TYPE THHW, THWN, THWN-2, XHHW, XHHW-2, THW, THW-2, RHW, OR RHW-2 INSULATION UNLESS OTHERWISE SPECIFIED.

 10. SUPPLEMENTAL EQUIPMENT GROUND WIRING LOCATED INDOORS SHALL BE SINGLE COPPER CONDUCTOR (#6 OR LARGER) WITH
- TYPE THHW, THWN, THWN—2, XHHW, XHHW—2, THW, THW—2, RHW, OR RHW—2 INSULATION UNLESS OTHERWISE SPECIFIED.

 11. POWER AND CONTROL WIRING IN FLEXIBLE CORD SHALL BE MULTI—CONDUCTOR, TYPE SOOW CORD (#14 OR LARGER) UNLESS
- OTHERWISE SPECIFIED.

 12. POWER AND CONTROL WIRING FOR USE IN CABLE TRAY SHALL BE MULTI—CONDUCTOR, TYPE TO CABLE (#14 OR LARGER), WITH
- TYPE THHW, THWN, THWN-2, XHHW, XHHW-2, THW, THW-2, RHW, OR RHW-2 INSULATION UNLESS OTHERWISE SPECIFIED.

 13. ALL POWER AND GROUNDING CONNECTIONS SHALL BE CRIMP-STYLE, COMPRESSION WIRE LUGS AND WIRE NUTS BY THOMAS AND
- BETTS (OR EQUAL). LUGS AND WIRE NUTS SHALL BE RATED FOR OPERATION NOT LESS THAN 75°C (90°C IF AVAILABLE).

 14. RACEWAY AND CABLE TRAY SHALL BE LISTED OR LABELED FOR ELECTRICAL USE IN ACCORDANCE WITH NEMA, UL, ANSI/IEEE
- AND NEC.

 15. ELECTRICAL METALLIC TUBING (EMT), INTERMEDIATE METAL CONDUIT (IMC), OR RIGID METAL CONDUIT (RMC) SHALL BE USED FOR
- EXPOSED INDOOR LOCATIONS.

 16. ELECTRICAL METALLIC TUBING (EMT) OR METAL—CLAD CABLE (MC) SHALL BE USED FOR CONCEALED INDOOR LOCATIONS.
- 17. SCHEDULE 40 PVC UNDERGROUND ON STRAIGHTS AND SCHEDULE 80 PVC FOR ALL ELBOWS/90s AND ALL APPROVED ABOVE GRADE PVC CONDUIT.
- 18. LIQUID-TIGHT FLEXIBLE METALLIC CONDUIT (LIQUID-TITE FLEX) SHALL BE USED INDOORS AND OUTDOORS, WHERE VIBRATION OCCURS OR FLEXIBILITY IS NEEDED.
- OCCURS OR FLEXIBILITY IS NEEDED.

 19. CONDUIT AND TUBING FITTINGS SHALL BE THREADED OR COMPRESSION—TYPE AND APPROVED FOR THE LOCATION USED. SET
- SCREW FITTINGS ARE NOT ACCEPTABLE.

 20. CABINETS, BOXES AND WIRE WAYS SHALL BE LABELED FOR ELECTRICAL USE IN ACCORDANCE WITH NEMA, UL, ANSI/IEEE AND
- 21. WIREWAYS SHALL BE METAL WITH AN ENAMEL FINISH AND INCLUDE A HINGED COVER, DESIGNED TO SWING OPEN DOWNWARDS (WIREMOLD SPECMATE WIREWAY).
- 22. SLOTTED WIRING DUCT SHALL BE PVC AND INCLUDE COVER (PANDUIT TYPE E OR EQUAL).
- 23. CONDUITS SHALL BE FASTENED SECURELY IN PLACE WITH APPROVED NON-PERFORATED STRAPS AND HANGERS. EXPLOSIVE DEVICES (i.e. POWDER-ACTUATED) FOR ATTACHING HANGERS TO STRUCTURE WILL NOT BE PERMITTED. CLOSELY FOLLOW THE LINES OF THE STRUCTURE, MAINTAIN CLOSE PROXIMITY TO THE STRUCTURE AND KEEP CONDUITS IN TIGHT ENVELOPES. CHANGE IN DIRECTION TO ROUTE AROUND OBSTACLES SHALL BE MADE WITH CONDUIT OUTLET BODIES. CONDUIT SHALL BE INSTALLED IN A NEAT AND WORKMANLIKE MANNER. PARALLEL AND PERPENDICULAR TO STRUCTURE WALL AND CEILING LINES. ALL CONDUIT SHALL BE FISHED TO CLEAR OBSTRUCTIONS. ENDS OF CONDUITS SHALL BE TEMPORARILY CAPPED FLUSH TO FINISH GRADE TO PREVENT CONCRETE. PLASTER OR DIRT FROM ENTERING. CONDUITS SHALL BE RIGIDLY CLAMPED TO BOXES BY GALVANIZED
- MALLEABLE IRON BUSHING ON INSIDE AND GALVANIZED MALLEABLE IRON LOCKNUT ON OUTSIDE AND INSIDE.

 24. EQUIPMENT CABINETS, TERMINAL BOXES, JUNCTION BOXES AND PULL BOXES SHALL BE GALVANIZED OR EPOXY—COATED SHEET STEEL. SHALL MEET OR EXCEED UL 50 AND BE RATED NEMA 1 (OR BETTER) FOR INTERIOR LOCATIONS AND NEMA 3R (OR BETTER). FOR EXTERIOR LOCATIONS.
- 25. METAL RECEPTACLE, SWITCH AND DEVICE BOXES SHALL BE GALVANIZED, EPOXY—COATED OR NON—CORRODING; SHALL MEET OR

 EXCEED UL 514A AND NEMA OS 1 AND BE RATED NEMA 1 (OR BETTER) FOR INTERIOR LOCATIONS AND WEATHER PROTECTED

 (WP OR BETTER) FOR EXTERIOR LOCATIONS.

 26. NONMETALLIC RECEPTACLE, SWITCH AND DEVICE BOXES SHALL MEET OR EXCEED NEMA OS 2 (NEWEST REVISION) AND BE RATED.
- 26. NONMETALLIC RECEPTACLE, SWITCH AND DEVICE BOXES SHALL MEET OR EXCEED NEMA OS 2 (NEWEST REVISION) AND BE RATED NEMA 1 (OR BETTER) FOR INTERIOR LOCATIONS AND WEATHER PROTECTED (WP OR BETTER) FOR EXTERIOR LOCATIONS.
 27. THE CONTRACTOR SHALL NOTIFY AND OBTAIN NECESSARY AUTHORIZATION FROM THE CARRIER AND/OR CROWN CASTLE USA INC. BEFORE COMMENCING WORK ON THE AC POWER DISTRIBUTION PANELS.
- 28. THE CONTRACTOR SHALL PROVIDE NECESSARY TAGGING ON THE BREAKERS, CABLES AND DISTRIBUTION PANELS IN ACCORDANCE WITH THE APPLICABLE CODES AND STANDARDS TO SAFEGUARD LIFE AND PROPERTY.
 29. INSTALL LAMICOID LABEL ON THE METER CENTER TO SHOW "VERIZON".
- 30. ALL EMPTY/SPARE CONDUITS THAT ARE INSTALLED ARE TO HAVE A METERED MULE TAPE PULL CORD INSTALLED.

| COND | CONDUCTOR COLOR CODE | | | | | |
|--------------|----------------------|------------------|--|--|--|--|
| SYSTEM | CONDUCTOR | COLOR | | | | |
| | A PHASE | BLACK | | | | |
| 120/240V, 1Ø | B PHASE | RED | | | | |
| 120/2400, 10 | NEUTRAL | WHITE | | | | |
| | GROUND | GREEN | | | | |
| | A PHASE | BLACK | | | | |
| | B PHASE | RED | | | | |
| 120/208V, 3Ø | C PHASE | BLUE | | | | |
| | NEUTRAL | WHITE | | | | |
| | GROUND | GREEN | | | | |
| | A PHASE | BROWN | | | | |
| | B PHASE | ORANGE OR PURPLE | | | | |
| 277/480V, 3Ø | C PHASE | YELLOW | | | | |
| | NEUTRAL | GREY | | | | |
| | GROUND | GREEN | | | | |
| DC VOLTAGE | POS (+) | RED** | | | | |
| DC VOLIAGE | NEG (-) | BLACK** | | | | |

* SEE NEC 210.5(C)(1) AND (2)
** POLARITY MARKED AT TERMINATION

FACILITY INTERFACE FRAME

LONG TERM EVOLUTION

NATIONAL ELECTRIC CODE

MASTER GROUND BAR

RADIO BASE STATION

REMOTE RADIO HEAD

SMART INTEGRATED DEVICE

TOWER MOUNTED AMPLIFIER

UNIVERSAL MOBILE TELECOMMUNICATIONS SYSTEM

REMOTE RADIO UNIT

REMOTE ELECTRIC TILT

RADIO FREQUENCY DATA SHEET

GLOBAL POSITIONING SYSTEM

GLOBAL SYSTEM FOR MOBILE

ABBREVIATIONS:

GEN

GPS

GSM

MGB

MW

NEC

QTY

RBS

RET

RFDS

RRH

RRU

SIAD

TYP

UMTS

W.P.

RECT

ANTENNA

EXISTING

GENERATOR

MICROWAVE

PROPOSED

QUANTITY

RECTIFIER

WORK POINT

POWER PLANT

NEW

RED ELECTRIC POWER LINES, CABLES, CONDUIT, AND LIGHTING CABLES

GAS, OIL, STEAM, PETROLEUM, OR
GASEOUS MATERIALS
COMMUNICATION. ALARM OR SIGNAL LINES.

LURRY LINES

APWA UNIFORM COLOR CODE:

EMPORARY SURVEY MARKINGS

CABLES, OR CONDUIT AND TRAFFIC LOOPS

WHITE PROPOSED EXCAVATION

BLUE POTABLE WATER

RECLAIMED WATER, IRRIGATION, AND

GREEN SEWERS AND DRAIN LINES

JURISDICTIONAL APPROVAL:





BELLEVUE, WA 98008

VERIZON SITE NUMBER: 115542

BU #: **845141 SB05-01 MT SOLOMON**MOUNTAIN SOLOMON AT
HIGHWAY 101
SANTA MARIA, CA 93454
EXISTING 100'-0" SELF SUPPORT
TOWER

| , etc. | | | | | | |
|--------|-------------|------|-------------|--------|--|--|
| | ISSUED FOR: | | | | | |
| REV | DATE | DRWN | DESCRIPTION | DES./Q | | |
| Α | 05/06/2021 | SA | 90% CD'S | MS | | |
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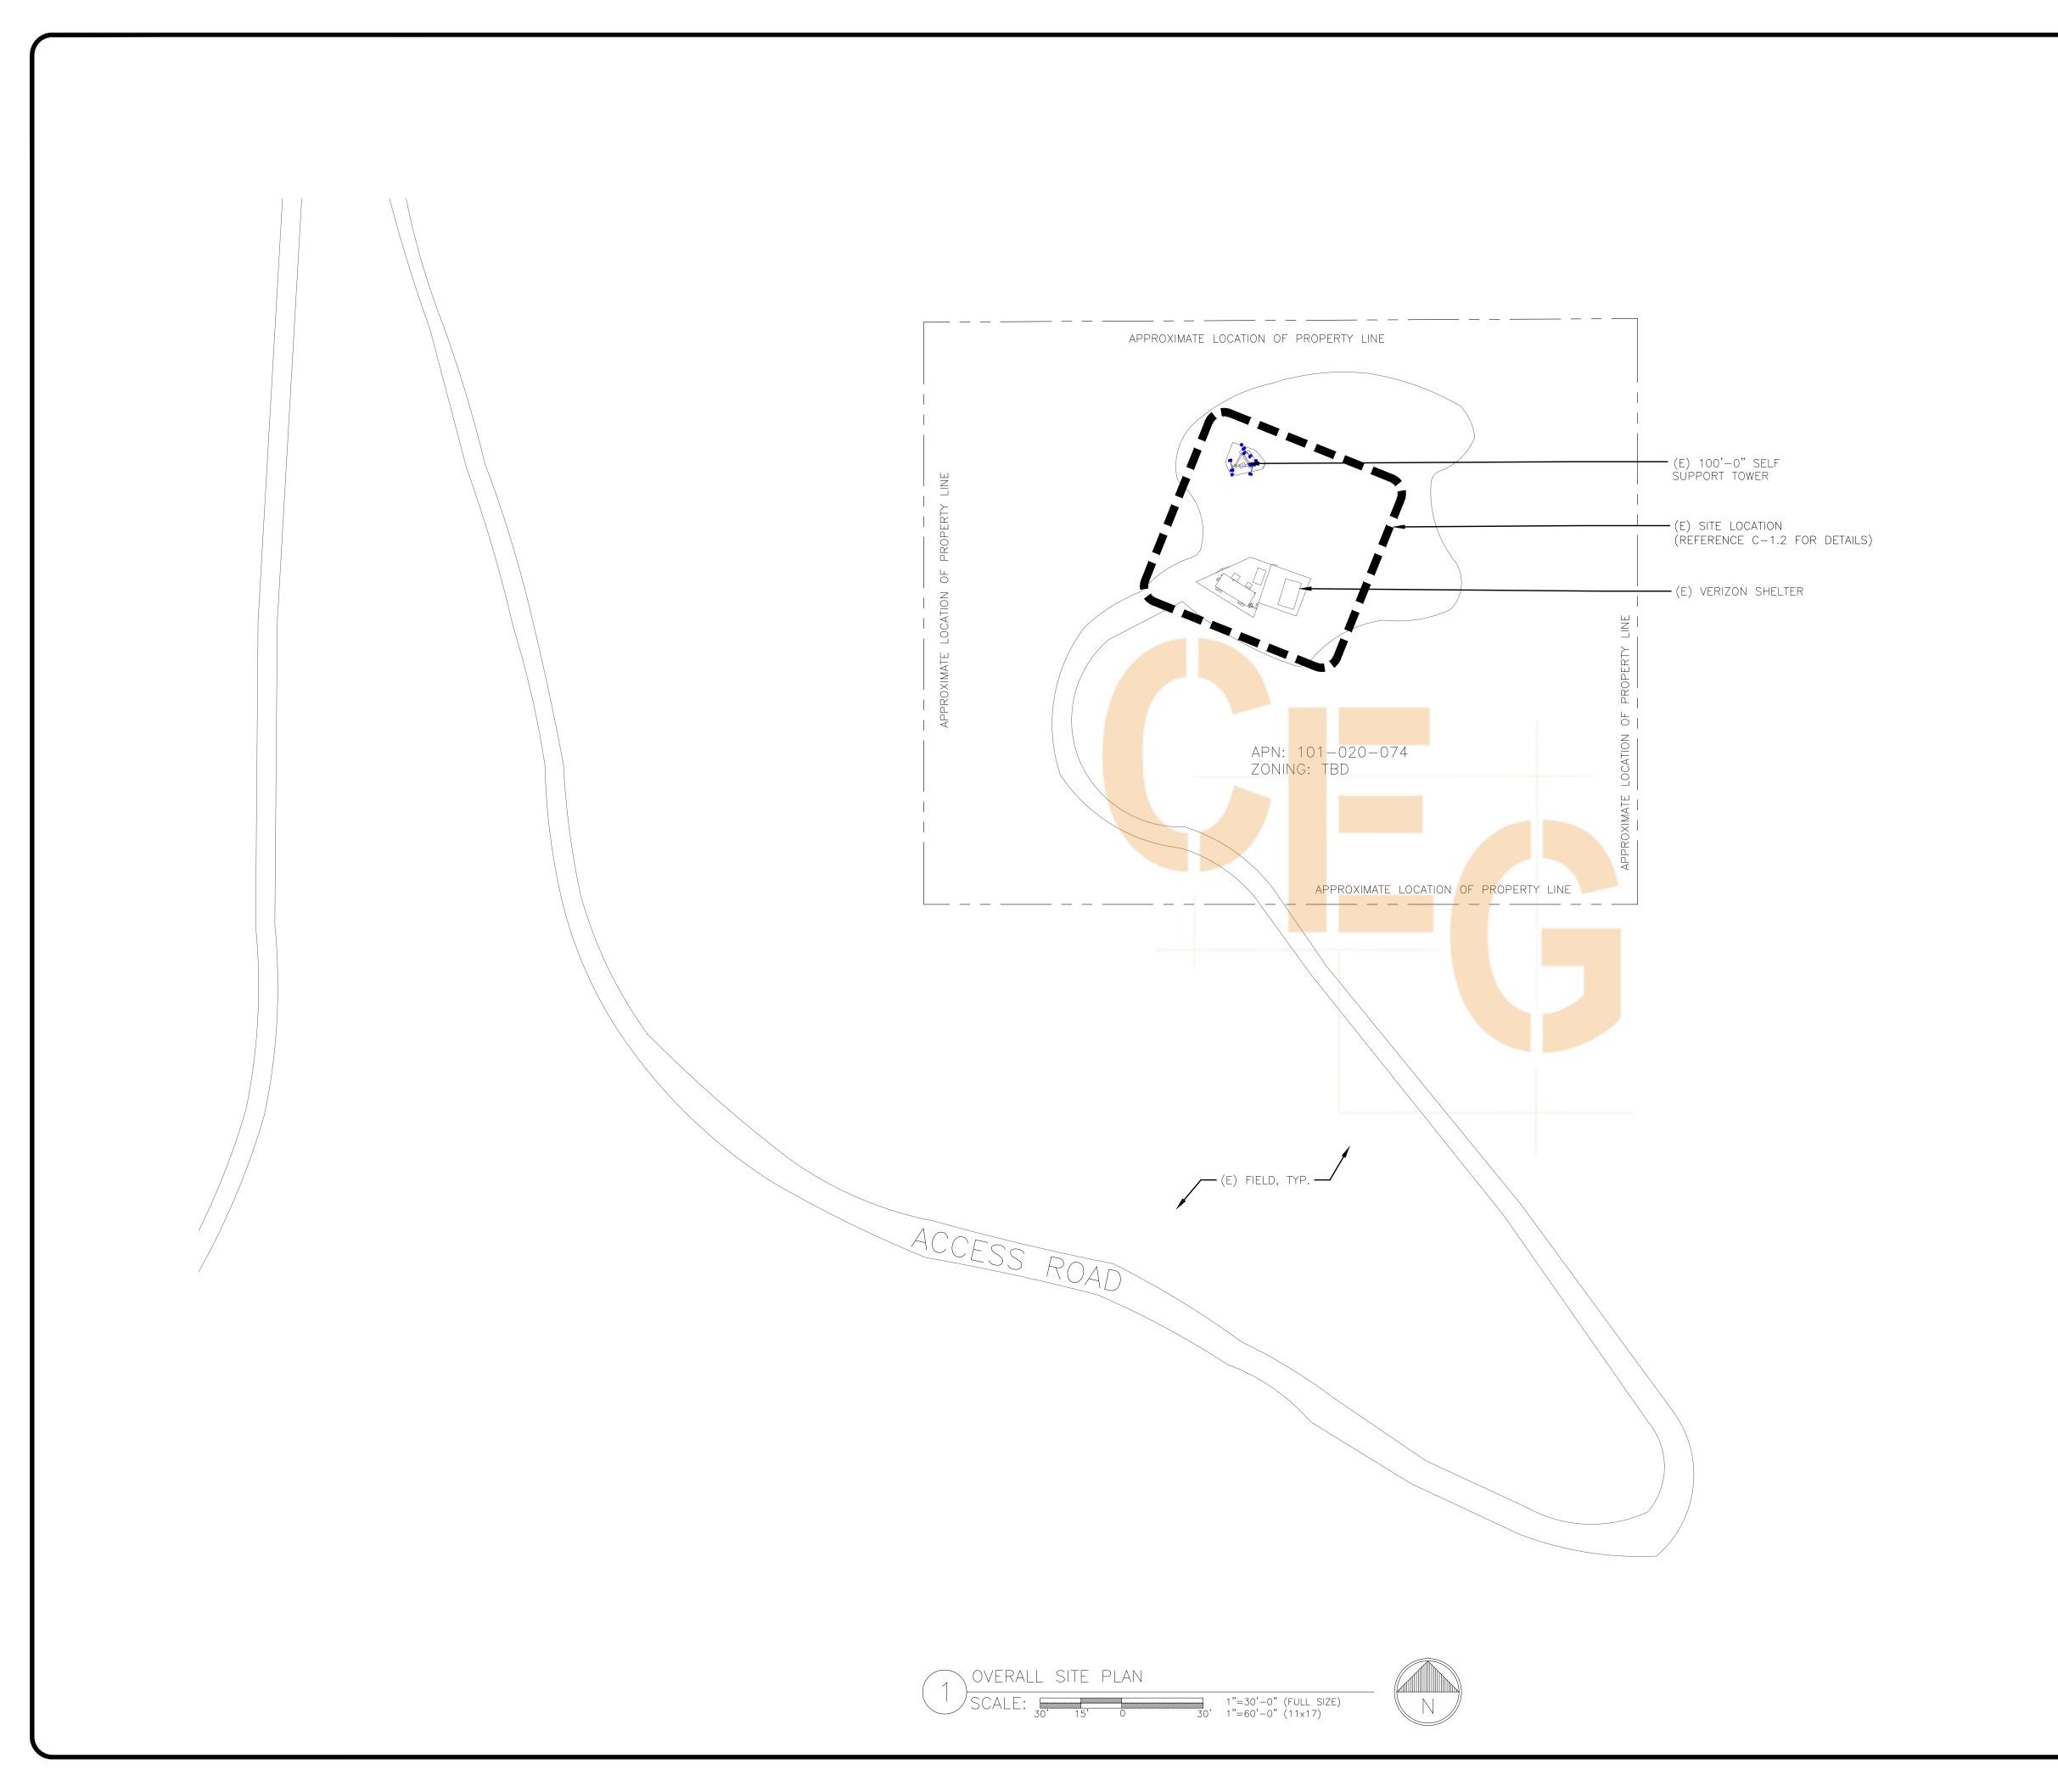
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SHEET NUMBER:

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SITE PLAN DISCLAIMER:

PROPERTY LINES AND STRUCTURES HAVE
BEEN DIGITIZED FROM PREVIOUS PLAN
SETS. CROWN CASTLE USA INC. HAS NOT
COMPLETED A SITE SURVEY AND
THEREFORE MAKES NO CLAIMS AS TO
THE ACCURACY OF INFORMATION
DEPICTED ON THIS SHEET.

JURISDICTIONAL APPROVAL:



3245 158TH AVENUE MS 231 BELLEVUE, WA 98008



SEATTLE, WA 98109

VERIZON SITE NUMBER: 115542

BU #: **845141 SB05-01 MT SOLOMON**

MOUNTAIN SOLOMON AT
HIGHWAY 101
SANTA MARIA, CA 93454
EXISTING 100'-0" SELF SUPPORT
TOWER

| | ISSUED FOR: | | | | | |
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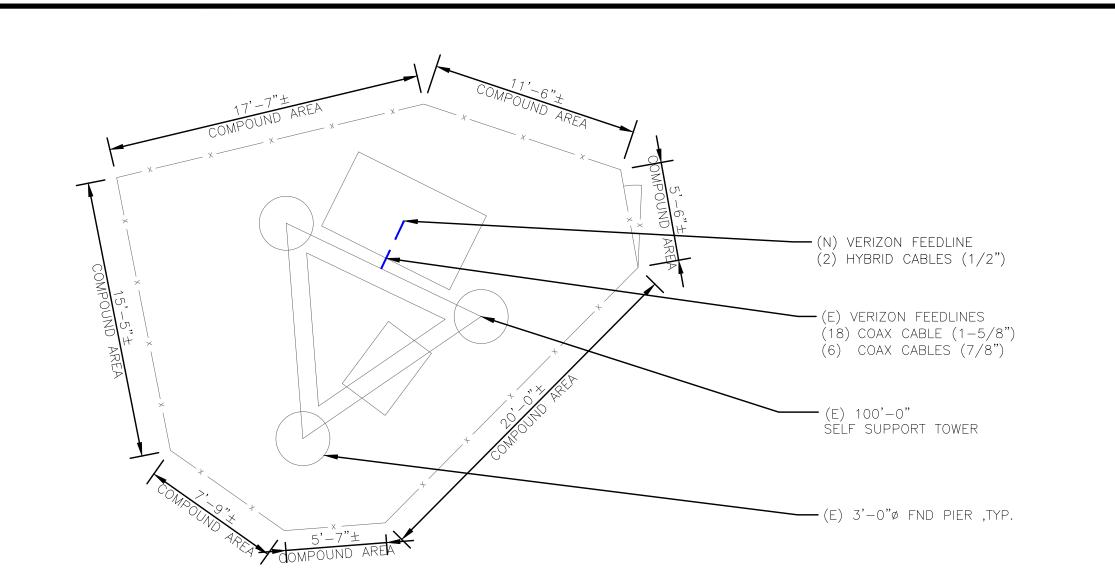
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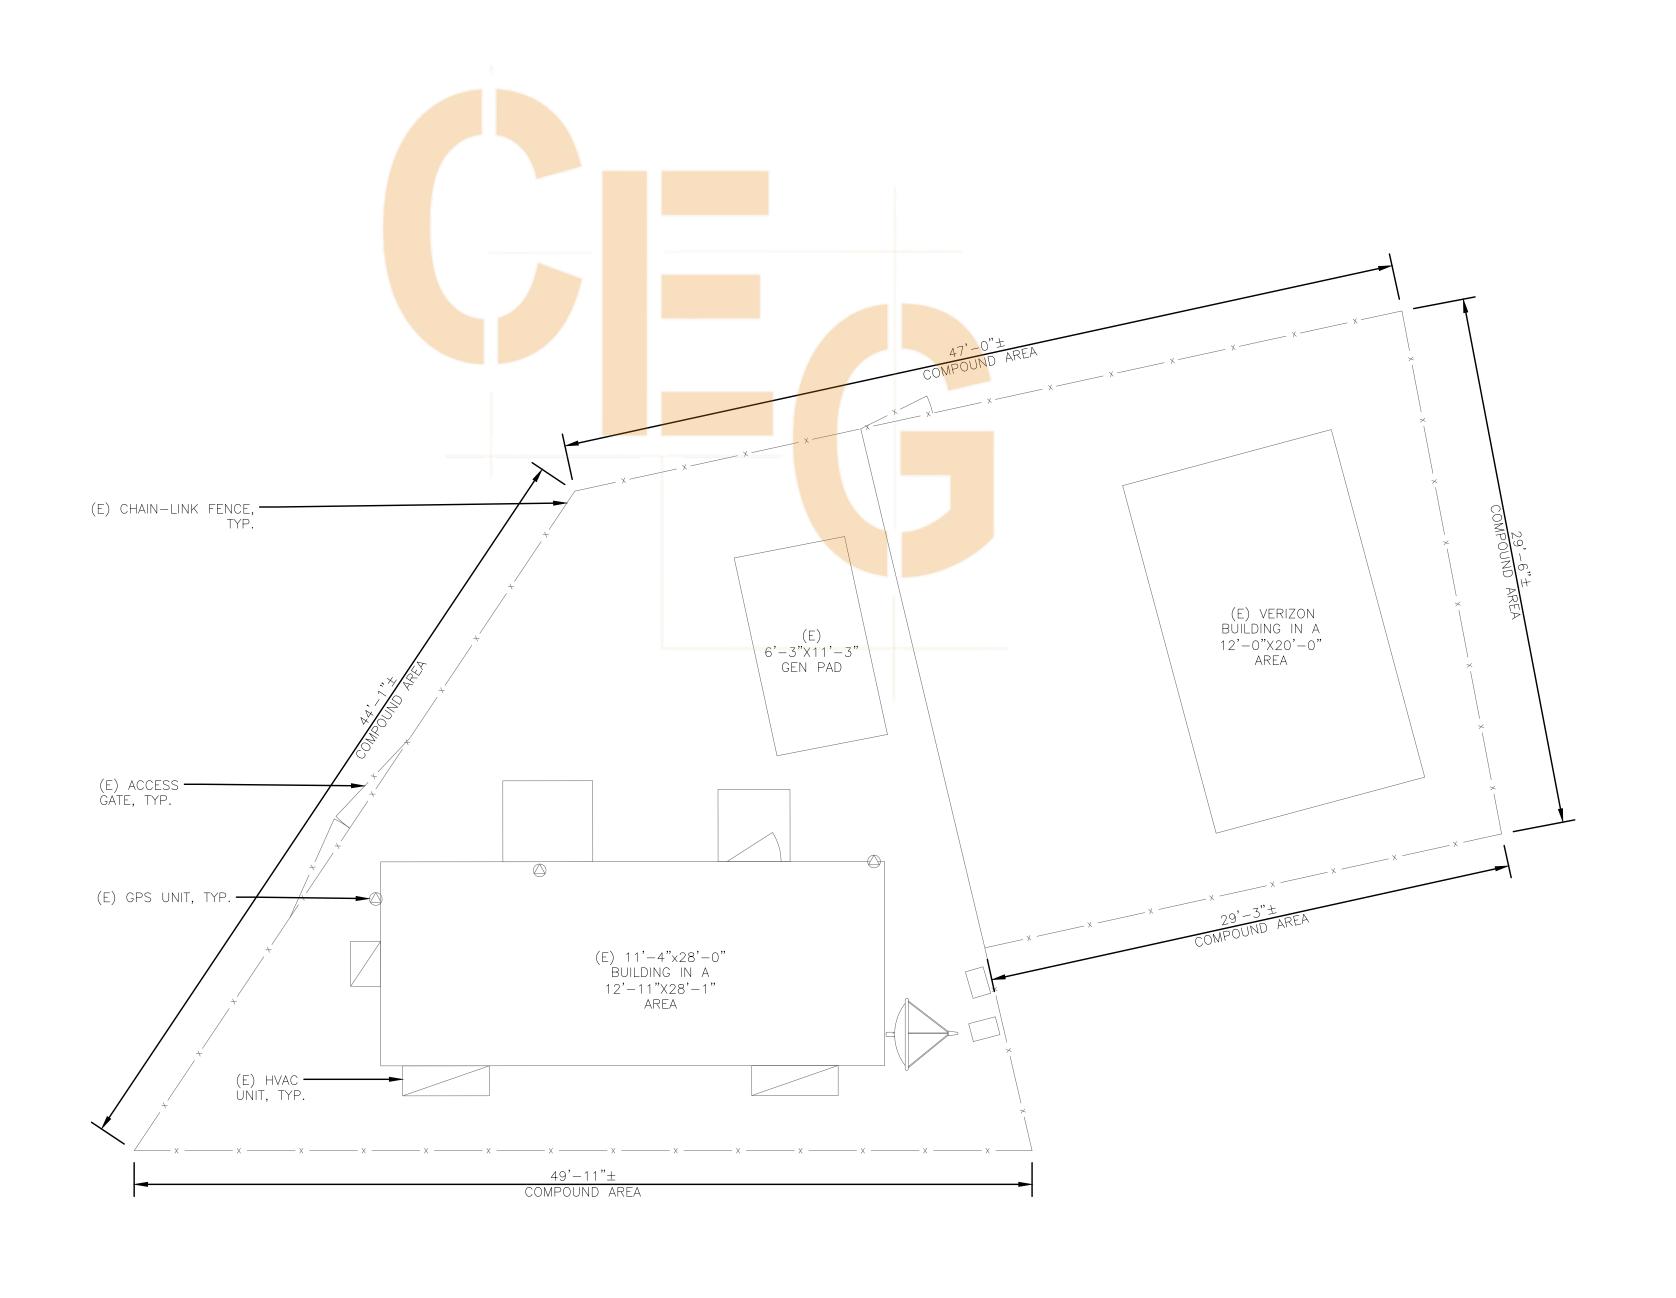
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C-1.1











BELLEVUE, WA 98008

CROWN CASTLE
1505 WESTLAKE AVENUE NORTH, SUITE 800

SEATTLE, WA 98109

VERIZON SITE NUMBER: 115542

BU #: **845141**

SB05-01 MT SOLOMON
MOUNTAIN SOLOMON AT
HIGHWAY 101
SANTA MARIA, CA 93454
EXISTING 100'-0" SELF SUPPORT
TOWER


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CROWN

BELLEVUE, WA 98008

1505 WESTLAKE AVENUE NORTH, SUITE 800 SEATTLE, WA 98109

VERIZON SITE NUMBER: 115542

SB05-01 MT SOLOMON

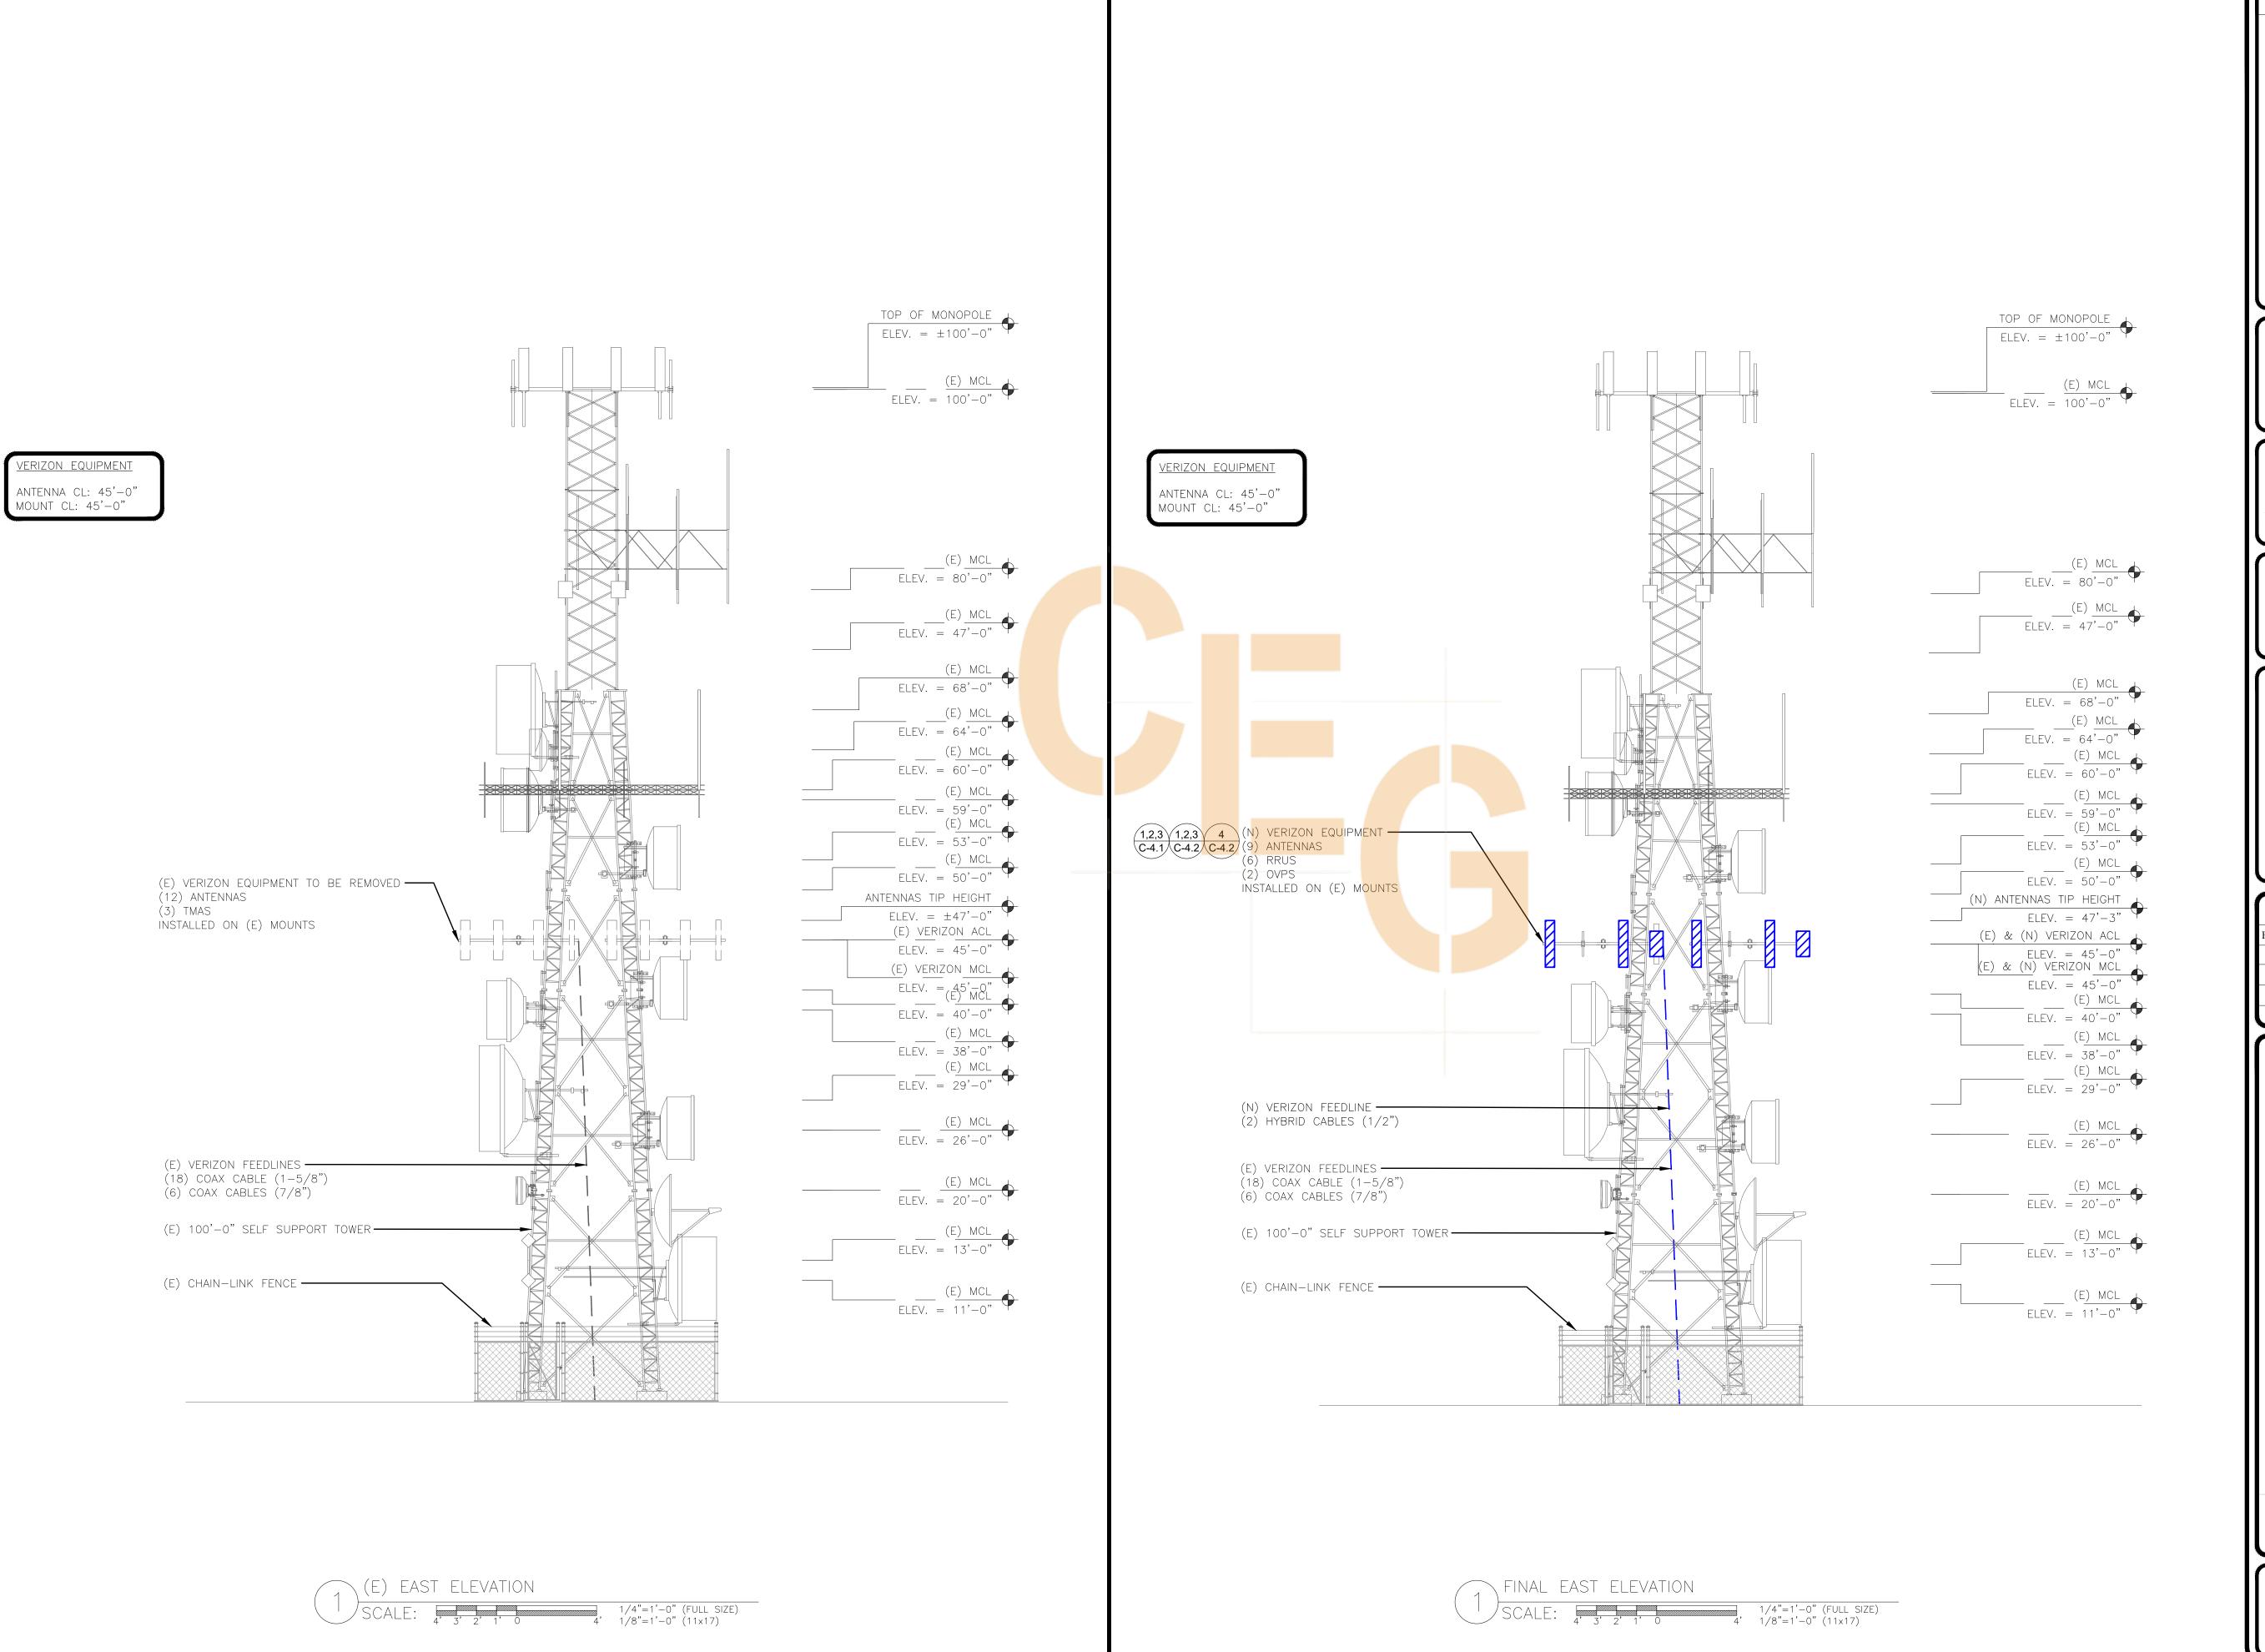MOUNTAIN SOLOMON AT

HIGHWAY 101

SANTA MARIA, CA 93454

EXISTING 100'-0" SELF SUPPORT

TOWER

BU #: **845141**

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SHEET NUMBER:

C-2



| | ANTENNA SCHEDULE | | | | | | | | | |
|--------|------------------|------------|---------------|---------|-------------------------|----------------|---------------|----------------|-----------------------------|---------------|
| SECTOR | POS. | TECHNOLOGY | RAD CENTER | AZIMUTH | ANTENNA MANUFACTURER | ANTENNA MODEL | MECH. TILT | ELECT. TILT | TOWER MOUNTED EQUIPMENT | FEEDLINE TYPE |
| ALPHA | A1 | _ | 45'-0" | 50° | TBD | L-SUB6 ANTENNA | 0° | 3° | (1) RAYCAP RCMDC-6627-PF-48 | HYBRID |
| ALPHA | A2 | - | 45'-0" | 50° | COMMSCOPE | NHH-65A-R2B | 0° | 0° | (1) RRUS 4449 | COAX |
| ALPHA | А3 | _ | 45'-0" | 50° | COMMSCOPE | NHH-65A-R2B | 0° | 0° | (1) RRUS 8843 | COAX |
| | | | | | | | | | | |
| BETA | В1 | _ | 45'-0" | 110° | TBD | L-SUB6 ANTENNA | O° | 3° | (1) RAYCAP RCMDC-6627-PF-48 | HYBRID |
| BETA | B2 | - | 45'-0" | 110° | COMMSCOPE | NHH-65A-R2B | 0° | 0° | (1) RRUS 4449 | COAX |
| BETA | В3 | _ | 45'-0" | 110° | COMMSCOPE | NHH-65A-R2B | 0° | 0° | (1) RRUS 8843 | COAX |
| | | | | | | | | | | |
| GAMMA | C1 | _ | 45'-0" | 260° | TBD | L-SUB6 ANTENNA | O° | 3° | | COAX |
| GAMMA | C2 | - | 45'-0" | 260° | COMMSCOPE | NHH-65A-R2B | 0° | 0° | (1) RRUS 4449 | COAX |
| GAMMA | C3 | _ | 45'-0" | 260° | COMMSCOPE | NHH-65A-R2B | 0° | 0° | (1) RRUS 8843 | COAX |

| CABLE SCHEDULE | | | | |
|----------------|-------------------------|--------|----------|--|
| STATUS | CABLE TYPE | SIZE | QUANTITY | |
| (E) | COAX | 1-5/8" | 18 | |
| (E) | COAX | 7/8" | 6 | |
| (N) | HYBRID | 1/2" | 2 | |
| FIN | FINAL CABLE QUANTITY 26 | | | |





VERIZON SITE NUMBER: 115542

BU #: **845141** SB05-01 MT SOLOMON MOUNTAIN SOLOMON AT


HIGHWAY 101 SANTA MARIA, CA 93454 EXISTING 100'-0" SELF SUPPORT TOWER


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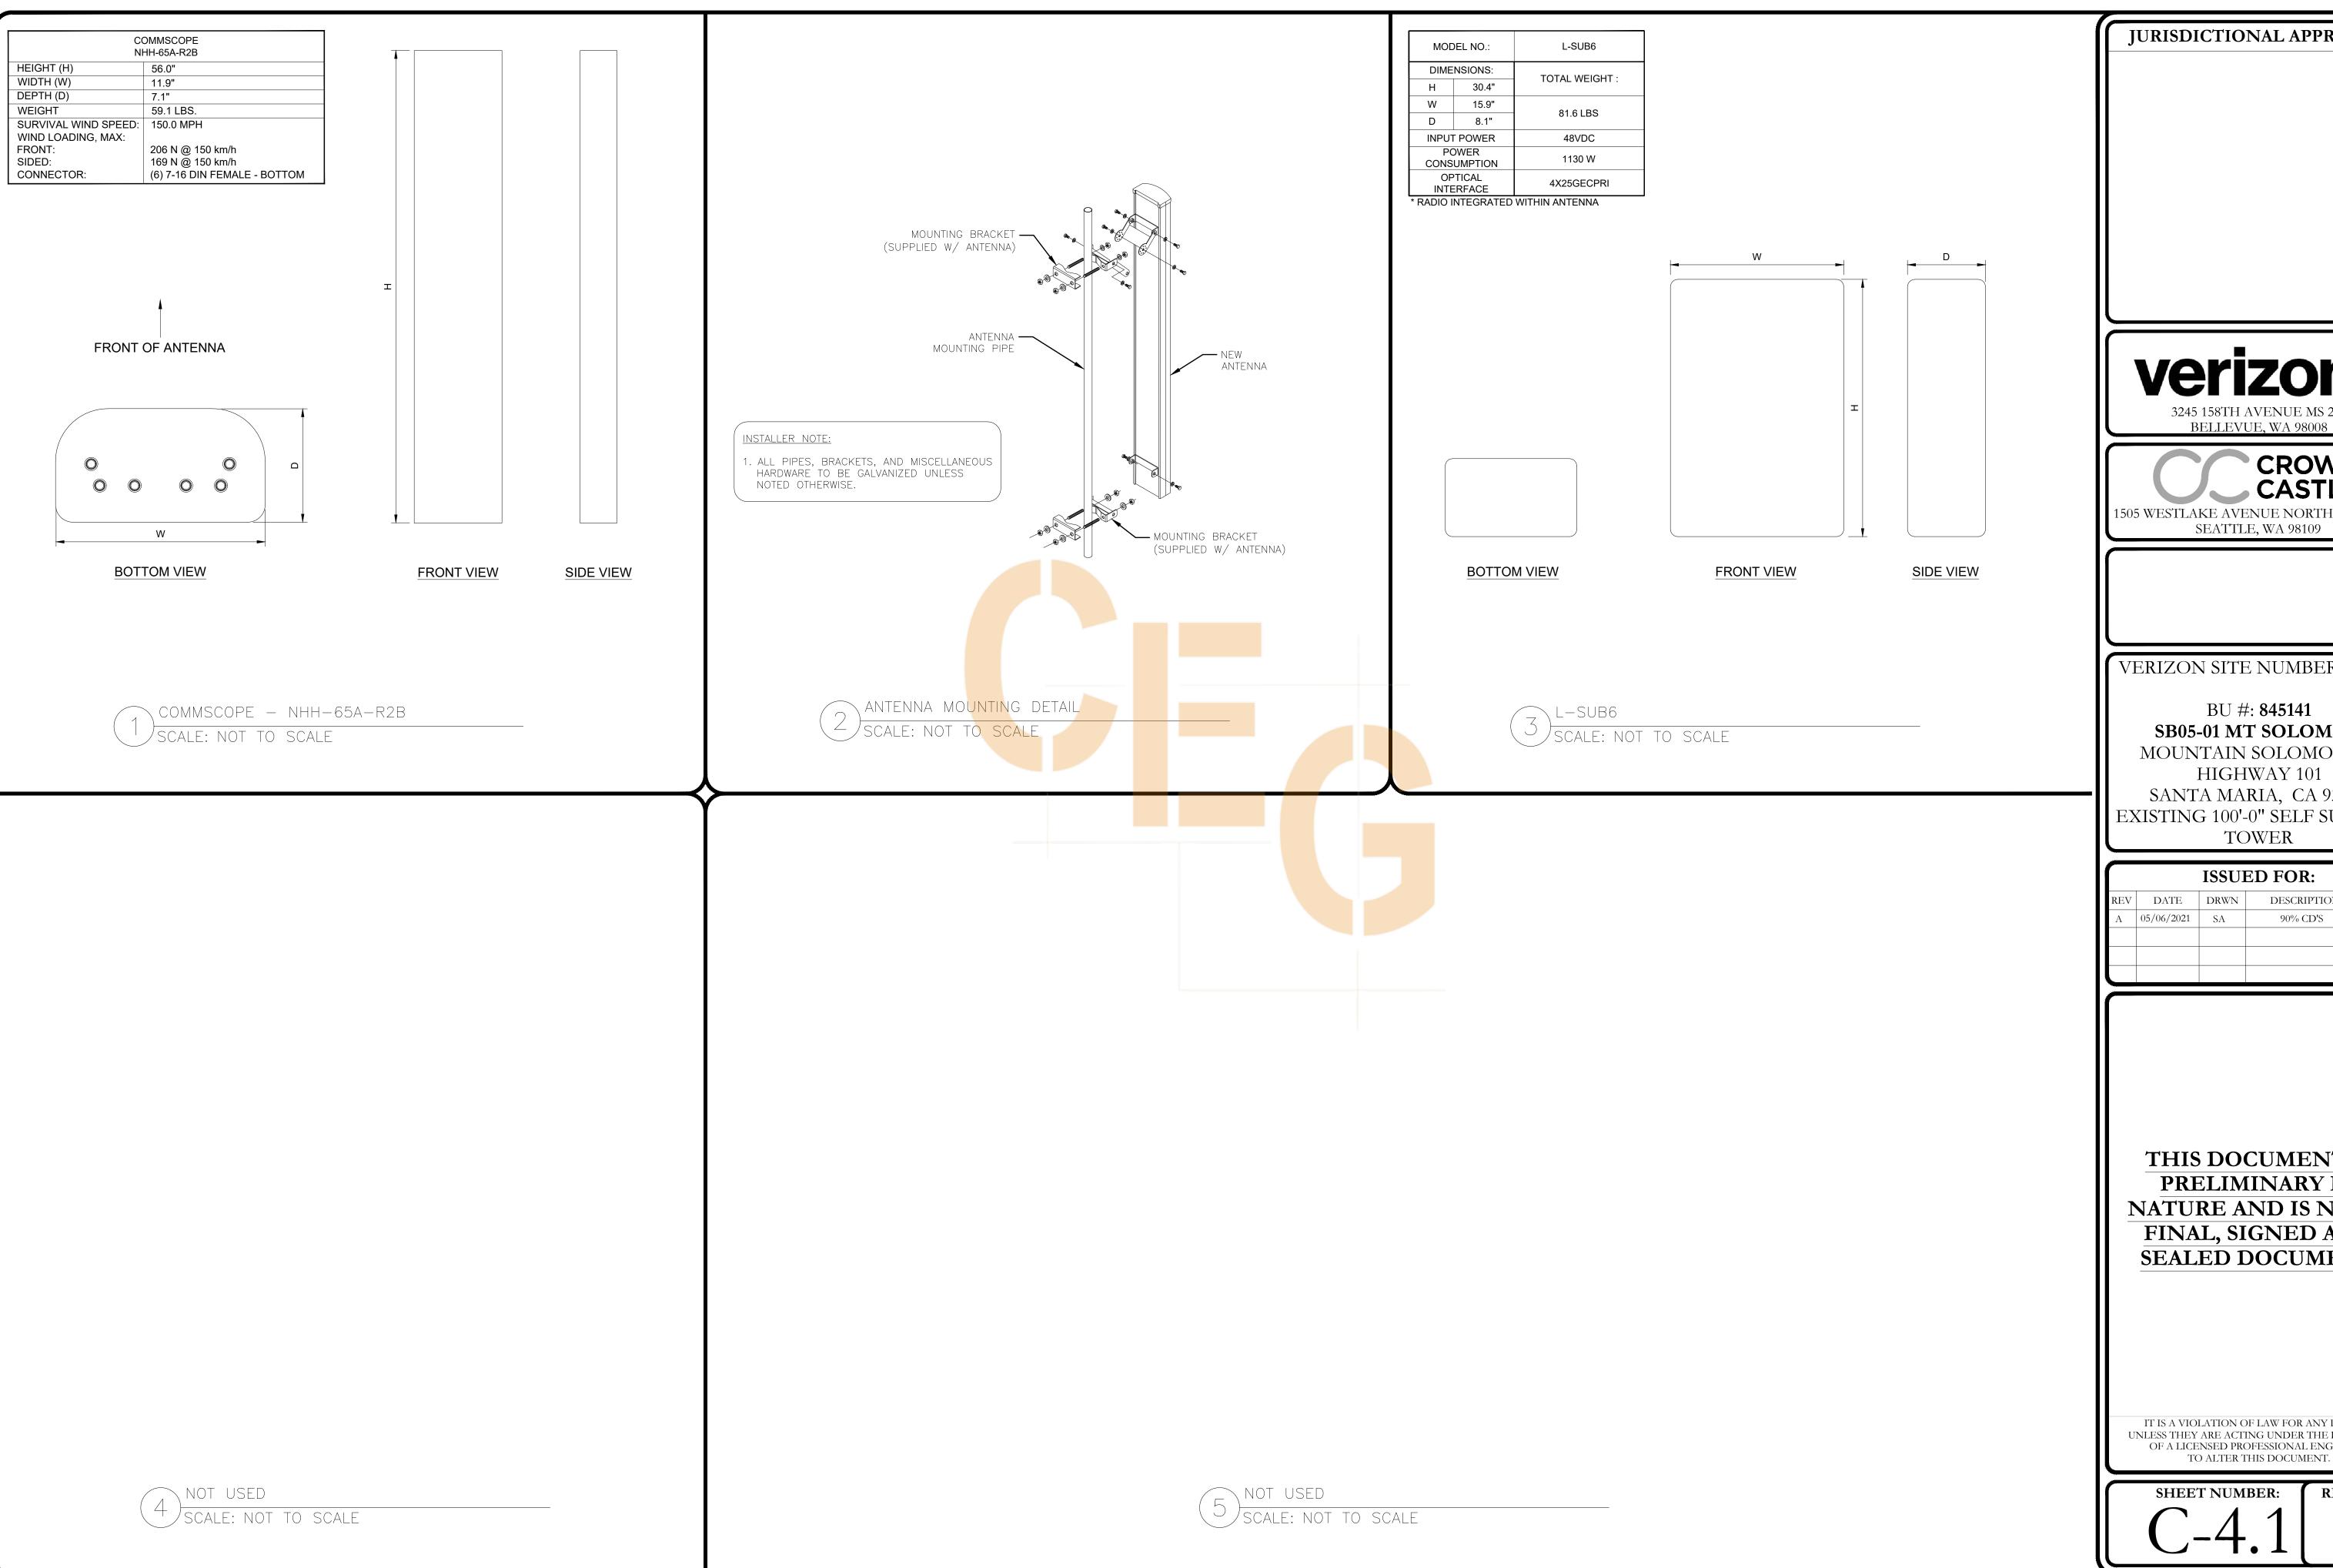
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SHEET NUMBER:





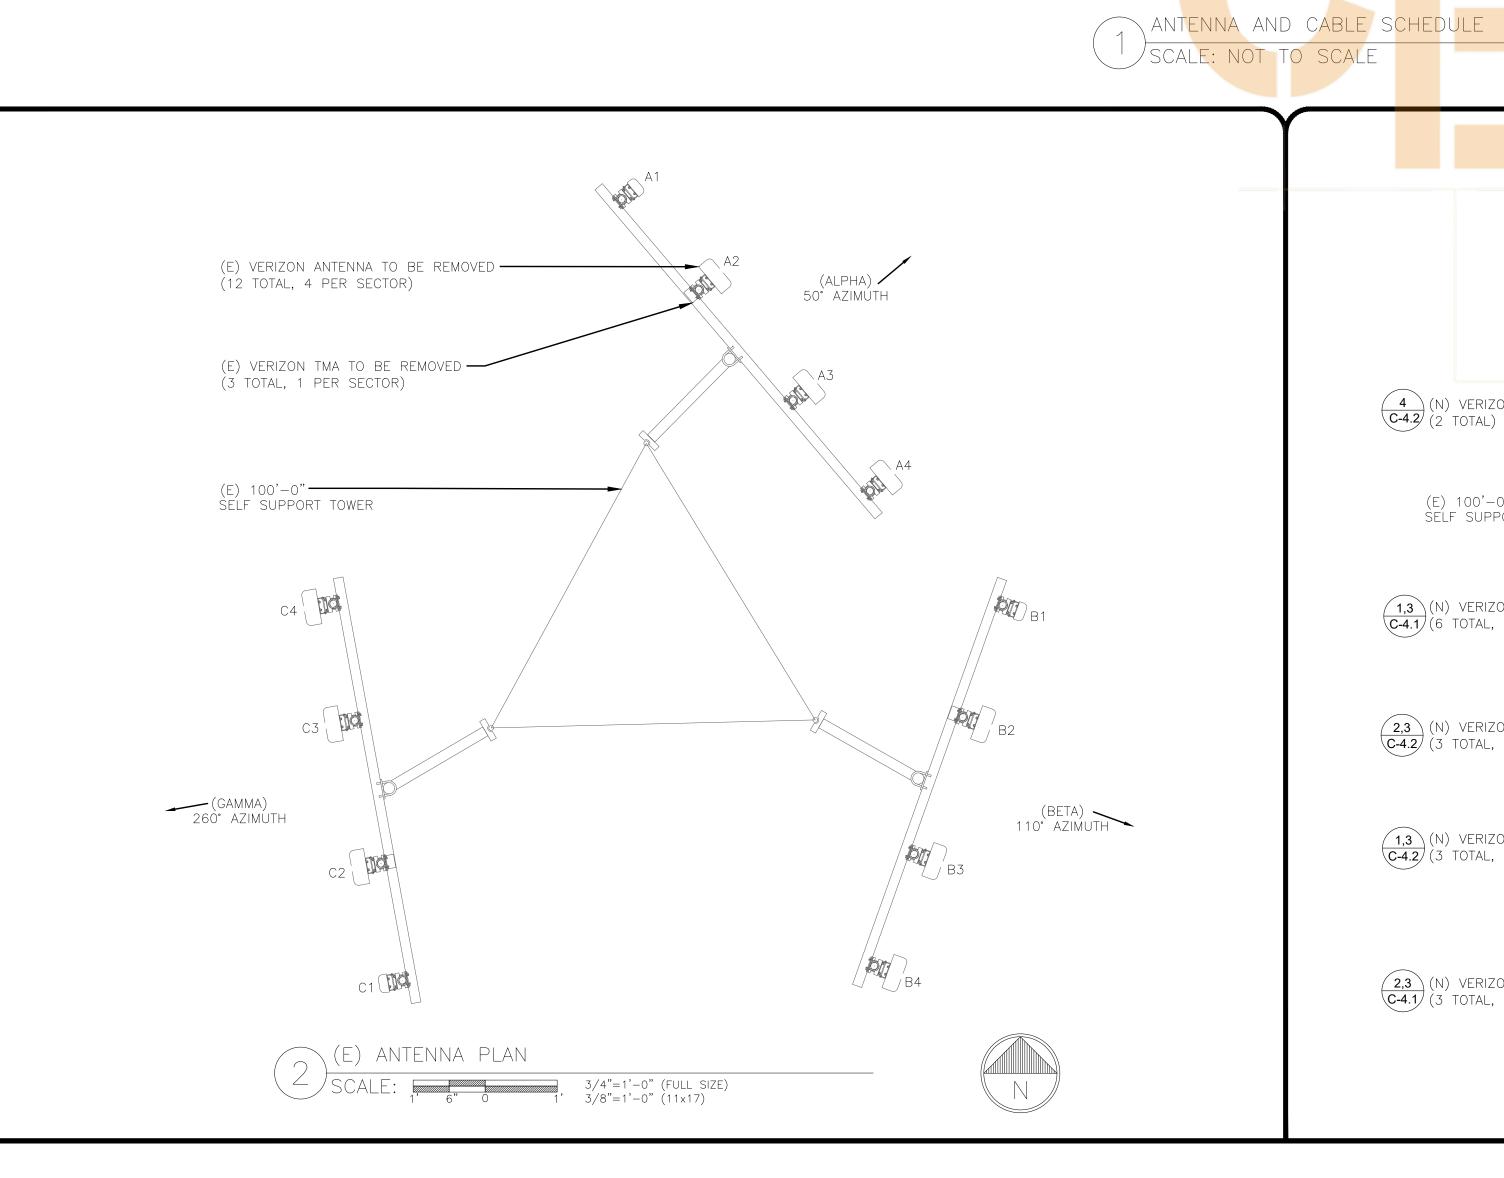

3245 158TH AVENUE MS 231

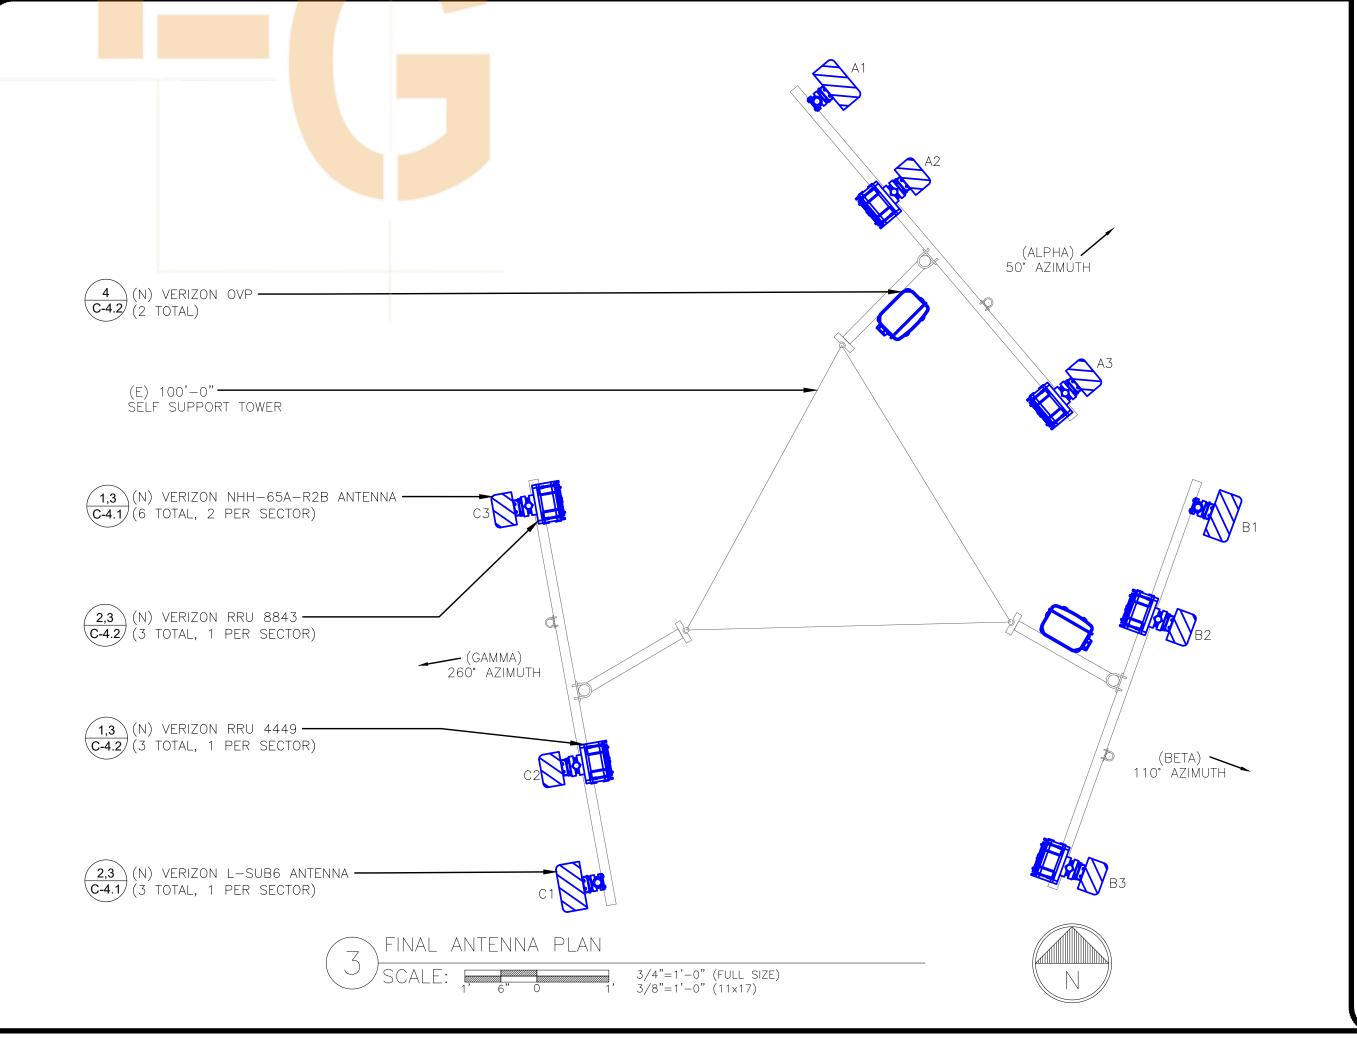CROWN CASTLE 1505 WESTLAKE AVENUE NORTH, SUITE 800 SEATTLE, WA 98109

VERIZON SITE NUMBER: 115542

BU #: **845141** SB05-01 MT SOLOMON


MOUNTAIN SOLOMON AT HIGHWAY 101 SANTA MARIA, CA 93454 EXISTING 100'-0" SELF SUPPORT TOWER


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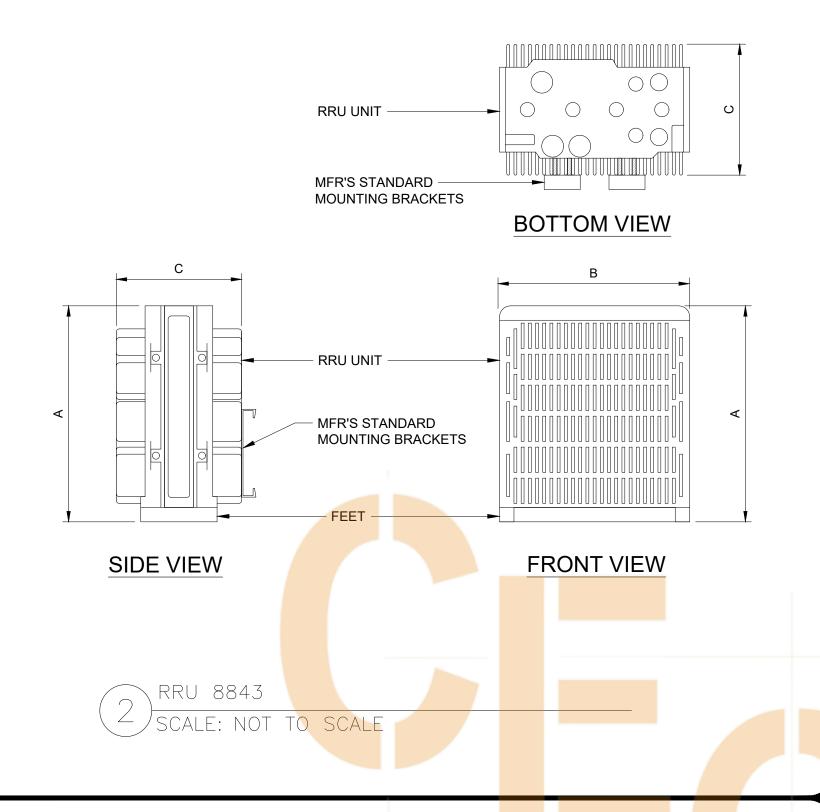
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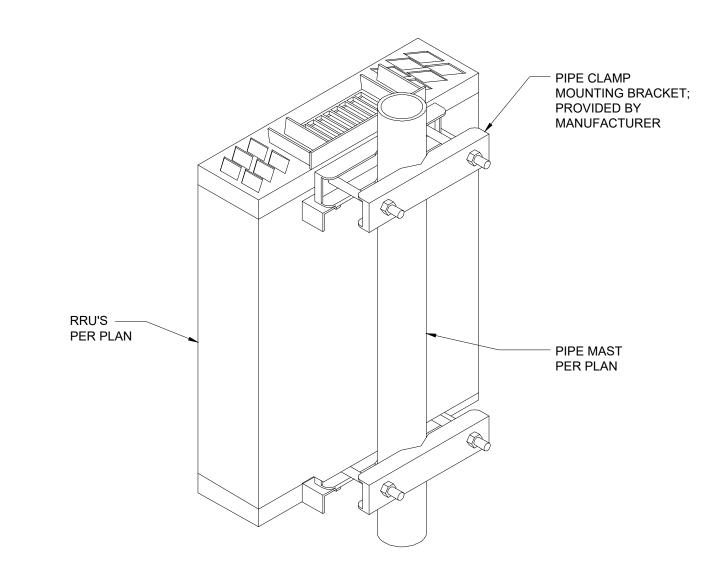
SHEET NUMBER:





| MANUF. | ACTURER: | ERICSSON | | | |
|--------|----------|-----------------|--|--|--|
| MOD | EL NO.: | RRUS 8843 | | | |
| DIME | NSIONS: | TOTAL WEIGHT : | | | |
| Α | 18" | TOTAL WEIGHT. | | | |
| В | 13.2" | 75 I DC (24 kg) | | | |
| С | 11.3" | 75 LBS (34 kg) | | | |

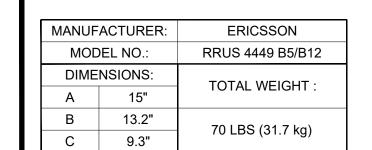

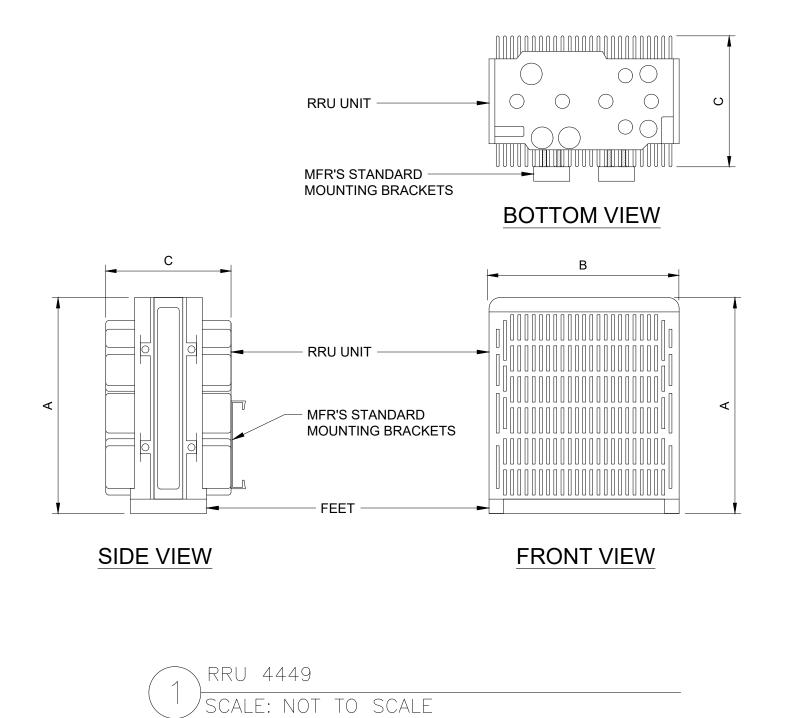

RRU MOUNTING DETAIL

SCALE: NOT TO SCALE

Verizon 3245 158TH AVENUE MS 231 BELLEVUE, WA 98008

JURISDICTIONAL APPROVAL:

CROWN CASTLE

1505 WESTLAKE AVENUE NORTH, SUITE 800 SEATTLE, WA 98109

VERIZON SITE NUMBER: 115542

BU #: 845141 SB05-01 MT SOLOMON

MOUNTAIN SOLOMON AT
HIGHWAY 101
SANTA MARIA, CA 93454
EXISTING 100'-0" SELF SUPPORT
TOWER


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SHEET NUMBER:







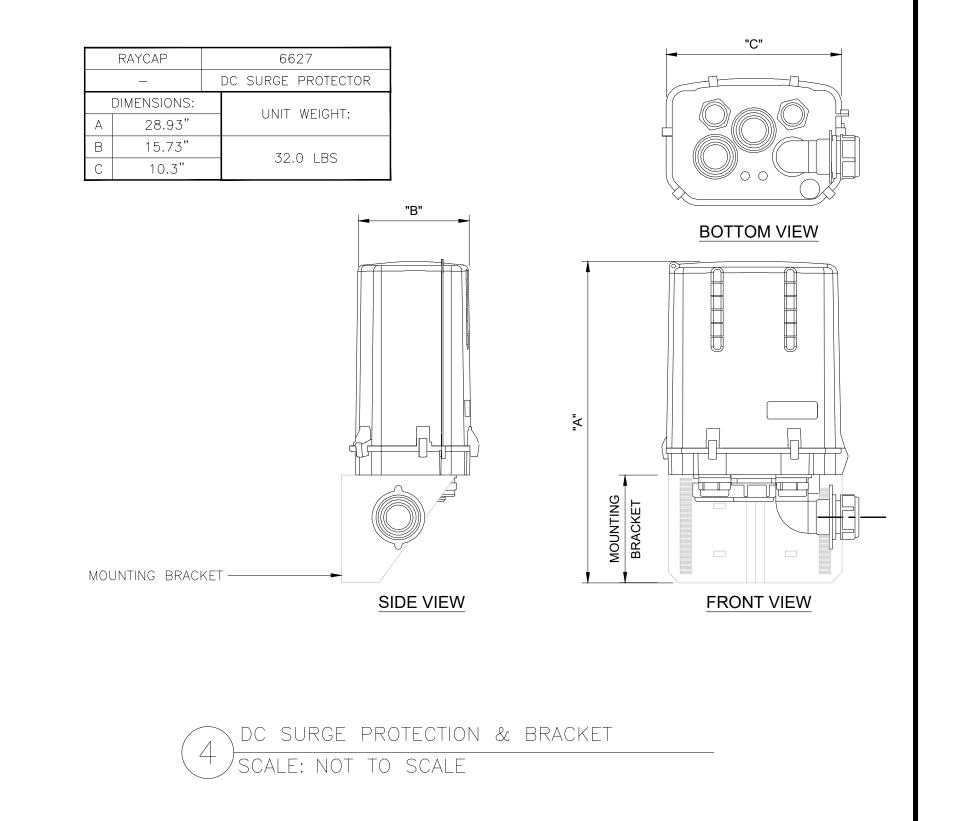

WEST > Pacific > Northern California/Nevada > Santa Barbara/San Luis > SANTA MARIA

Gomez, Eduardo - eduardo.gomez@verizonwireless.com - 2/8/2021 13:16:14

| Project Details | Location Information | | |
|---|---|--|--|
| Carrier Aggregation: false | Site ID: 463743 | | |
| MPT Id: | E-NodeB ID: 033447,0339447 | | |
| eCIP-0: false | PSLC: 115542 | | |
| Project Name: 5G L-Sub6 - Carrier Add | Switch Name: Pleasanton | | |
| FUZE Project ID: 16241846 | Tower Owner: | | |
| Designed Sector Carrier 4G: 18 | Tower Type: Self Support (Lattice Tower) | | |
| Designed Sector Carrier 5G: N/A | Site Type: MACRO | | |
| Additional Sector Carrier 4G: N/A | Street Address: Solomon Mountain | | |
| Additional Sector Carrier 5G: N/A | City: ORCUTT | | |
| SiteTraker Project Id: | State: CA | | |
| FP Solution Type & Tech Type: MODIFICATION;5G_L-Sub6-Prep | Zip Code: 93454 | | |
| Suffix: | County: Santa Barbara | | |
| | Latitude: 34.834897 / 34° 50' 5.6292" N | | |
| | Longitude: -120.383356 / 120° 23' 0.0816" W | | |

RFDS Project Scope: SOW: 5G Ls6 project.

- Add 3 new Antennas for 5G Ls6 project
- 5G Ls6 new Azimuth 60/180/300
- Remove (9) existing Verizon wireless antennas and replace them with (9) new antennas with (3) antenna per sector
- Remove (3) RRUS 12 B4 for AWS at the tower.
- Add (3) RRU8843 for AWS1&3/PCS LTE at the antenna.
- Remove (3) RRU 2212 B5 for 850LTE in the shelter.
- Replace existing L700 Radio 2xRUL01 B13 with 3 new 4449 dual band radio.
- * L700 & CDMA will remain diplexed and LTE 850 Will be 2Tx/2Rx and L700 will be 4Tx/4Rx.
- Remove (3) TMA in the 700 line at the tower.
- Add (3) RRU4449 for 850 LTE/700 LTE at the antenna.
- Combine CDMA radios with and 700L/850L Kaelus Diplexer (10MHz LTE)
- Keep existing run of 7/8" coax cables.
- CX check skew angles/antenna positions on the CD
- Hybrid Cable and OVP Box: Check with Cx. on Model/Type/Quantity

NOTE: The VZE01 is an integrated radio/antenna and should be considered one unit

Proprietary and Confidential. Not for disclosure outside of Verizon.



JURISDICTIONAL APPROVAL:





VERIZON SITE NUMBER: 115542

BU #: **845141 SB05-01 MT SOLOMON**MOUNTAIN SOLOMON AT

HIGHWAY 101
SANTA MARIA, CA 93454
EXISTING 100'-0" SELF SUPPORT
TOWER

| | ISSUED FOR: | | | | | |
|-----|-------------|------|-------------|---------|--|--|
| REV | DATE | DRWN | DESCRIPTION | DES./QA | | |
| A | 05/06/2021 | SA | 90% CD'S | MS | | |
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SHEET NUMBER:

C-5







CROWN

BELLEVUE, WA 98008

1505 WESTLAKE AVENUE NORTH, SUITE 800 SEATTLE, WA 98109

VERIZON SITE NUMBER: 115542

BU #: **845141 SB05-01 MT SOLOMON**

MOUNTAIN SOLOMON AT
HIGHWAY 101
SANTA MARIA, CA 93454
EXISTING 100'-0" SELF SUPPORT
TOWER


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|-------------|------------|------|-------------|---------|
| REV | DATE | DRWN | DESCRIPTION | DES./QA |
| A | 05/06/2021 | SA | 90% CD'S | MS |
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SHEET NUMBER:

C-6





CROWN CASTLE

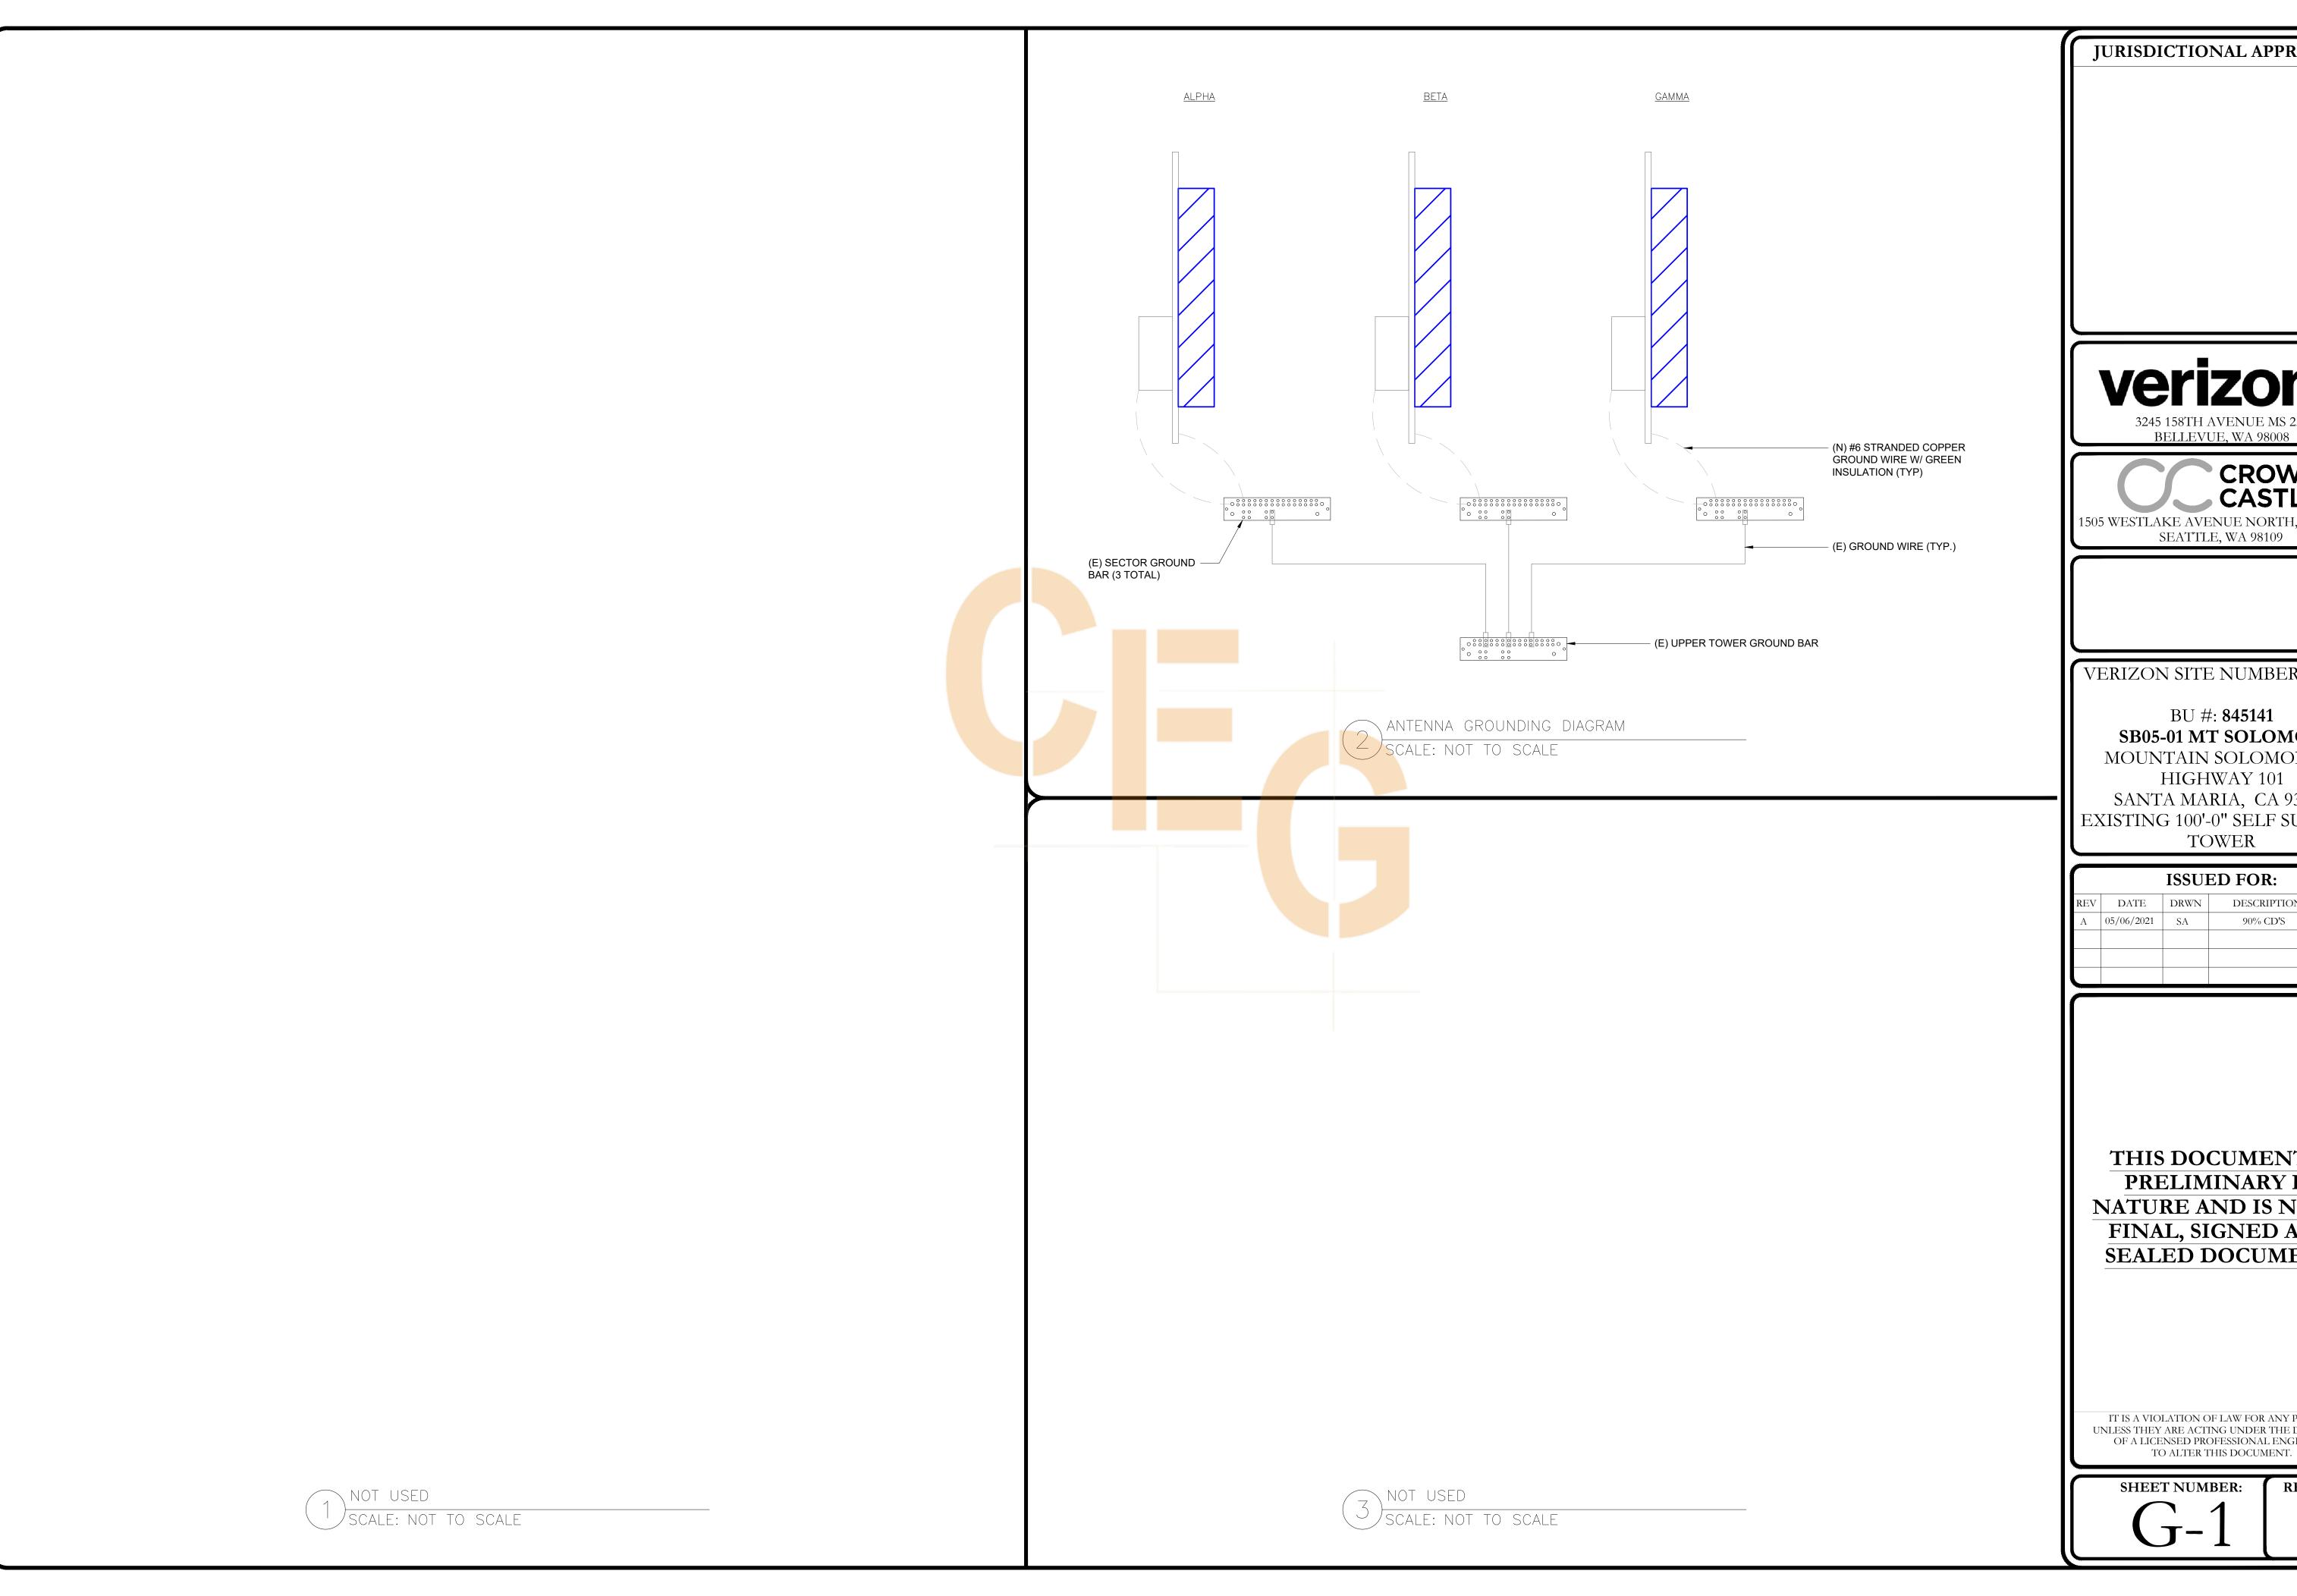1505 WESTLAKE AVENUE NORTH, SUITE 800 SEATTLE, WA 98109

VERIZON SITE NUMBER: 115542

BU #: **845141** SB05-01 MT SOLOMON


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|-------------|------------|------|-------------|---------|--|
| REV | DATE | DRWN | DESCRIPTION | DES./QA | |
| A | 05/06/2021 | SA | 90% CD'S | MS | |
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SHEET NUMBER:




<u>NOTES:</u>

- 1. DOUBLING UP "OR STACKING" OF CONNECTIONS IS NOT PERMITTED.
- 2. EXTERIOR ANTIOXIDANT JOINT COMPOUND TO BE USED ON ALL EXTERIOR CONNECTIONS.
- 3. GROUND BAR SHALL NOT BE ISOLATED FROM TOWER. MOUNT DIRECTLY TO ANTENNA MOUNT STEEL.

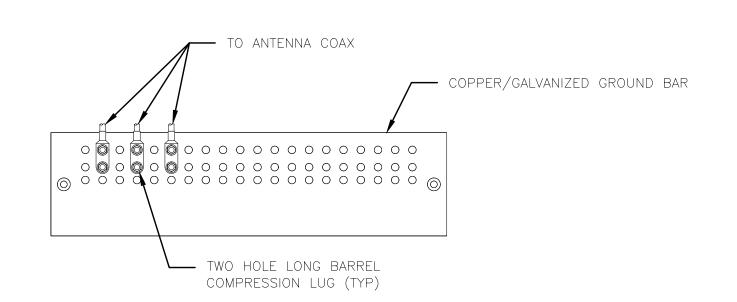


SCALE: NOT TO SCALE

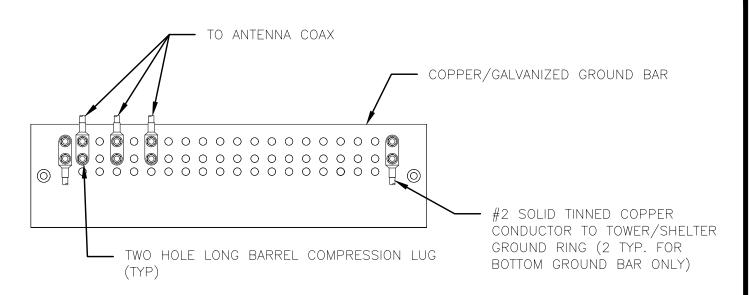

NOTES:

- 1. EXTERIOR ANTIOXIDANT JOINT COMPOUND TO BE USED ON ALL EXTERIOR CONNECTIONS.
- 2. GROUND BAR SHALL NOT BE ISOLATED FROM TOWER. MOUNT DIRECTLY TO TOWER STEEL (TOWER ONLY).
- 3. GROUND BAR SHALL BE ISOLATED FROM BUILDING OR SHELTER.




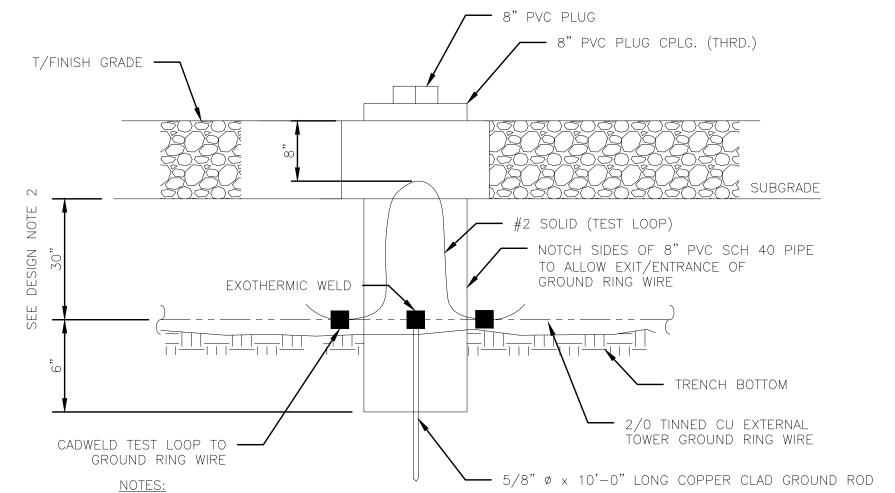

- 1. GROUND ROD SHALL BE DRIVEN VERTICALLY, NOT TO EXCEED 45 DEGREES FROM THE
- 2. GROUND WIRE SHALL BE MIN. 30" BELOW GRADE OR 6" BELOW FROST LINE.





CROWN (WHICH EVER IS GREATER) AS PER N.E.C. ARTICLE 250-50(D) **CASTLE** 1505 WESTLAKE AVENUE NORTH, SUITE 800 SEATTLE, WA 98109

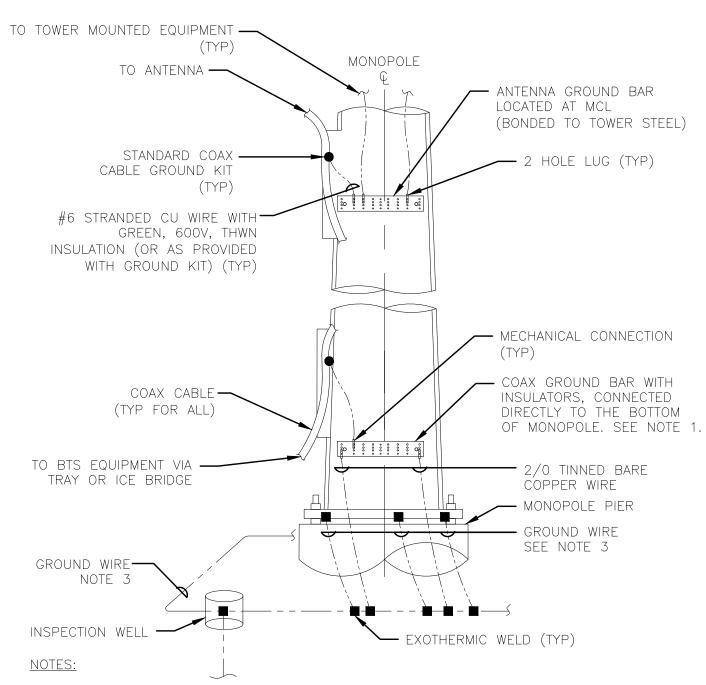

- 1. NUMBER OF GROUNDING BARS MAY VARY DEPENDING ON THE TYPE OF TOWER, ANTENNA LOCATIONS AND CONNECTION ORIENTATION. COAXIAL CABLES EXCEEDING 200 FEET ON THE TOWER SHALL HAVE GROUND KITS AT THE MIDPOINT. PROVIDE AS REQUIRED.
- 2. ONLY MECHANICAL CONNECTIONS ARE ALLOWED TO BE MADE TO CROWN CASTLE USA INC. TOWERS. ALL MECHANICAL CONNECTIONS SHALL BE TREATED WITH AN ANTI-OXIDANT COATING.
- 3. ALL TOWER GROUNDING SYSTEMS SHALL COMPLY WITH THE REQUIREMENTS OF THE RECOGNIZED EDITION OF ANSI/TIA 222 AND NFPA 780.



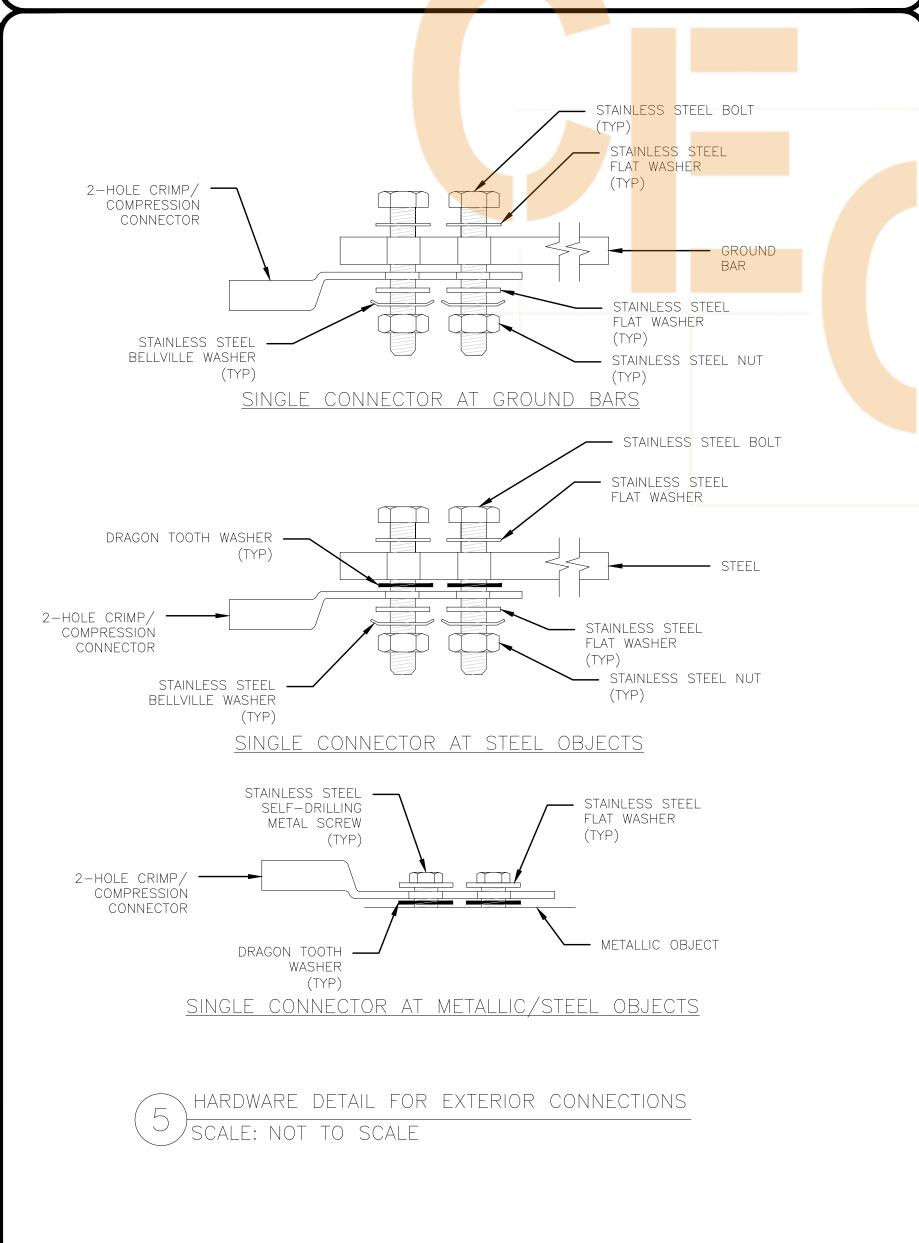

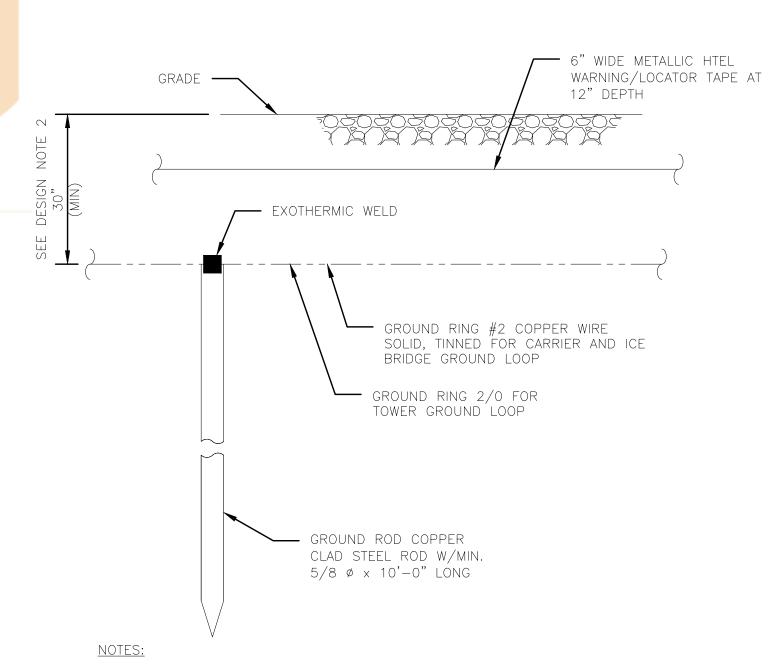

- 1. GROUND ROD SHALL BE DRIVEN VERTICALLY, NOT TO EXCEED 45 DEGREES FROM THE
- 2. GROUND WIRE SHALL BE MIN. 30" BELOW GRADE OR 6" BELOW FROST LINE. (WHICH EVER IS GREATER) AS PER N.E.C. ARTICLE 250-50(D)



VERIZON SITE NUMBER: 115542

3245 158TH AVENUE MS 231 BELLEVUE, WA 98008

JURISDICTIONAL APPROVAL:

BU #: **845141** SB05-01 MT SOLOMON MOUNTAIN SOLOMON AT HIGHWAY 101 SANTA MARIA, CA 93454 EXISTING 100'-0" SELF SUPPORT TOWER


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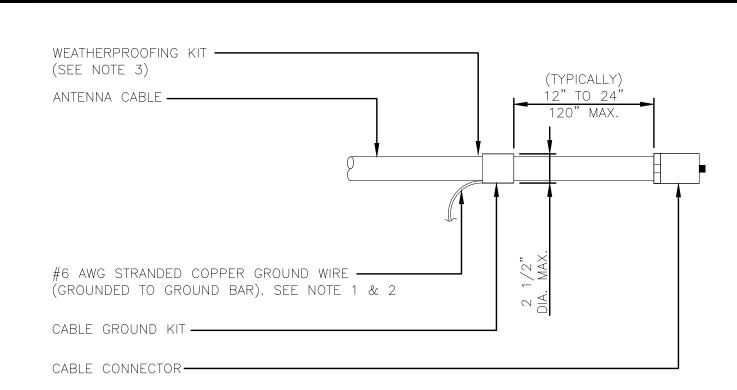
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- 1. ERICO EXOTHERMIC "MOLD TYPES" SHOWN HERE ARE EXAMPLES. CONSULT WITH CONSTRUCTION MANAGER FOR SPECIFIC
- 2. MOLD TYPE ONLY TO BE USED BELOW GRADE WHEN CONNECTING GROUND RING TO GROUND ROD.


CADWELD GROUNDING CONNECTIONS SCALE: NOT TO SCALE



- DO NOT INSTALL CABLE GROUND KIT AT A BEND AND ALWAYS DIRECT GROUND WIRE DOWN TO GROUND BAR.
- GROUNDING KIT SHALL BE TYPE AND PART NUMBER AS SUPPLIED OR RECOMMENDED BY CABLE MANUFACTURER.
- WEATHER PROOFING SHALL BE TWO-PART TAPE KIT, COLD SHRINK SHALL NOT


CABLE GROUND KIT CONNECTION

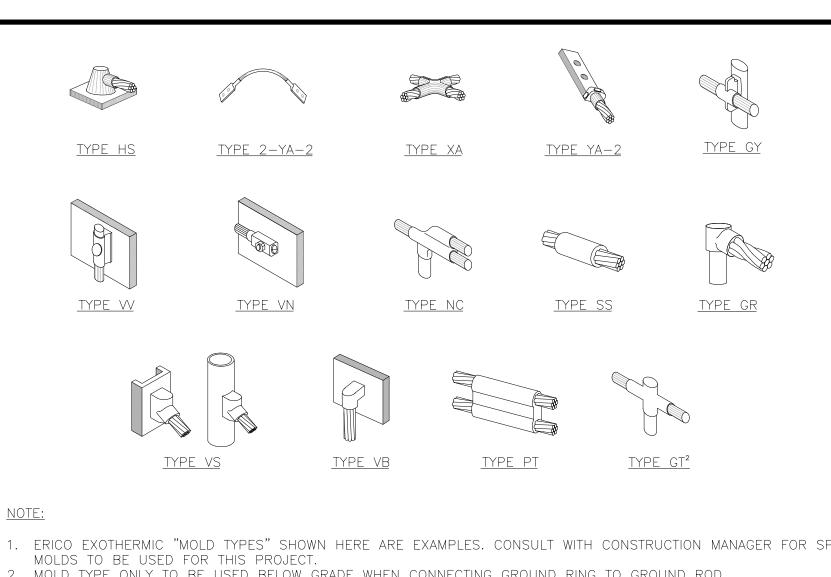SCALE: NOT TO SCALE

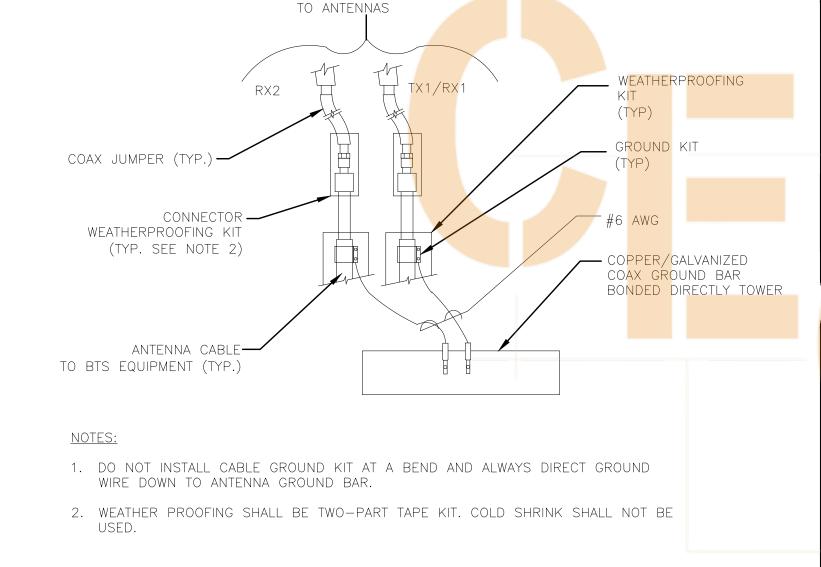



GROUND CABLE CONNECTION SCALE: NOT TO SCALE

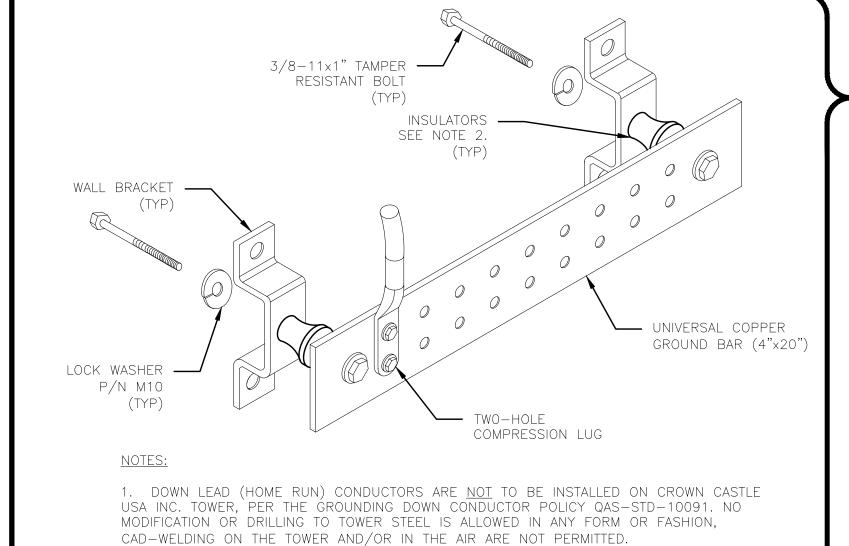



2. OMIT INSULATOR WHEN MOUNTING TO TOWER STEEL OR PLATFORM STEEL

USE INSULATORS WHEN ATTACHING TO BUILDING OR SHELTERS.

GROUND BAR DETAIL

SCALE: NOT TO SCALE

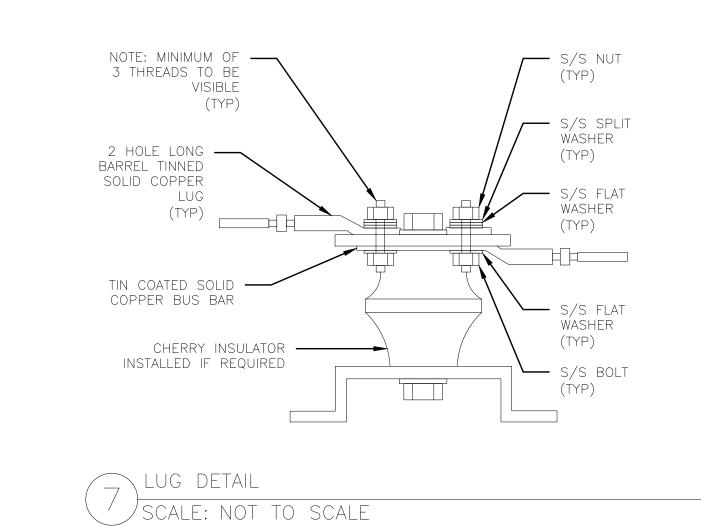

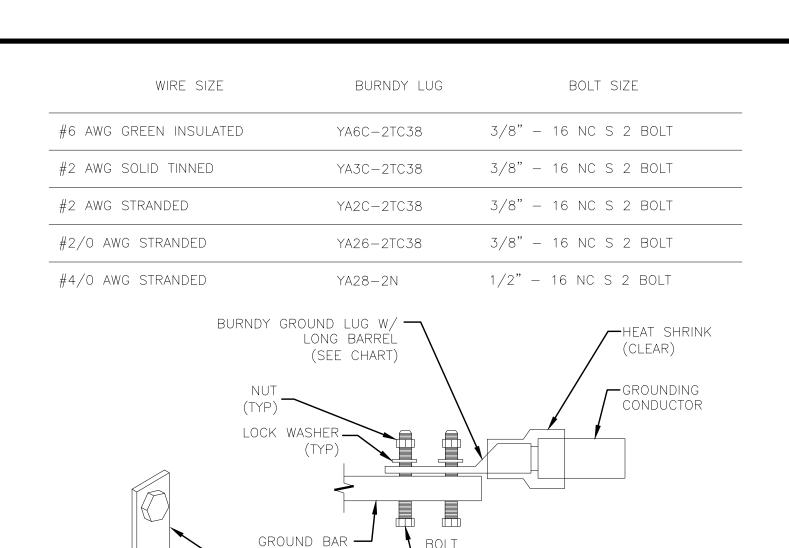

-BURNDY TWO HOLE LUG W/

LONG BARREL (SEE CHART)

1. ALL GROUNDING LUGS ARE TO BE INSTALLED PER MANUFACTURER'S SPECIFICATIONS.

ALL HARDWARE BOLTS, NUTS, LOCK WASHERS SHALL BE STAINLESS STEEL. ALL

HARDWARE ARE TO BE AS FOLLOWS: BOLT, FLAT WASHER, GROUND BAR, GROUND LUG,

<u>NOTES</u>:

GROUND BAR ON SHELTER. ICE-

*TWO HOLE LUG, OR-

THE LIQUID TIGHT CONDUIT MUST BE

SEALED WITH SILICONE CAULK.

BRIDGE, OR ON ANTENNA TOWER

EXOTHERMIC WELD TO BE USED

WITH #2 AWG BARE CONDUCTOR

WIRE TO BUILDING SERVICE GROUND OR GROUND RING

FLAT WASHER AND NUT.

MECHANICAL LUG CONNECTION

/SCALE: NOT TO SCALE

#6 AWG MIN. FROM ANTENNA

CABLE GROUND KIT

BARE WIRE TO BE

(SEE CHART)

NO-OX AT BOTH ENDS

►(SEE CHART)

-stranded (green insulated) only for #6 awg



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VERIZON SITE NUMBER: 115542

BU #: **845141** SB05-01 MT SOLOMON MOUNTAIN SOLOMON AT

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SHEET NUMBER:

REVISION:

GROUNDWIRE INSTALLATION SCALE: NOT TO SCALE SEALED DOCUMENT #2 TINNED SOLID IN 3/4" LIQUID TIGHT — CONDUIT FROM 24" BELOW GRADE TO WITHIN 3" TO 6" OF CAD-WELD TERMINATION POINT. EXPOSED END OF

-GROUNDING SHALL BE

METAL TOWER

ELIMINATED WHEN GROUND BAR

IS ELECTRICALLY BONDED TO

CADWELD -(TYP) TIE INTO (E) GROUND RING -

TRANSITIONING GROUND DETAIL SCALE: NOT TO SCALE